FOOTE'S REST AT BLOCK 11

FRISCO, SUMMIT COUNTY, CO

DEVELOPMENT APPLICATION

PROJECT TEAM

OWNER

512 MAIN STREET, LLC. P.O. BOX 307 FRISCO, CO 80443 PHONE: 970.389.2660

ARCHITECT

ROWLAND AND BROUGHTON 234 E HOPKINS AVE **ASPEN, CO 81611** PHONE: 970.544.9006

GENERAL CONTRACTOR

PINNACLE MOUNTAIN HOMES 335 N MAIN STREET BRECKENRIDGE, CO 80424 PHONE: 970.453.0708

CIVIL ENGINEER

JVA, INCORPORATED 47 COOPER CREEK WAY, SUITE 328 WINTER PARK, CO 80482 PHONE: 970.722.7677

STRUCTURAL ENGINEER

1717 WASHINGTON AVENUE, #100 GOLDEN, COLORADO 80401 PHONE: 303-575-9510

MECHANICAL, ELECTRICAL & PLUMBING ENGINEER

40801 US HWY 6, STE 214 AVON, CO 81620 PHONE: 970.390.7793

ISSUE DATES

05.15.2017: SKETCH PLAN / REZONE 01 06.28.2017: SKETCH PLAN / REZONE 02 09.07.2017: DEVELOPMENT APPLICATION

OWNER'S REPRESENTATIVE

GATEWAY MANAGEMENT CO P.O. BOX 1358 **ASPEN, CO 81612** PHONE: 970.948.1050

LANDSCAPE ARCHITECT

NORRIS DESIGN 409 MAIN STREET, SUITE 207 FRISCO, CO 80443 PHONE: 970.368.7068

SURVEYOR

SCHMIDT LAND SURVEYING, INC. PO BOX 5761 FRISCO, CO 80443 PHONE: 970.409.9963

GROUNDWATER ENGINEER

LEONARD RICE ENGINEERS, INC. 1221 AURARIA PKWY DENVER, CO 80204 PHONE: 303.455.9589

TRAFFIC ENGINEER

FELSBURG HOLT & ULLEVIG, INC. 6300 S.SYRACUASE WAY, STE 600 CENTENNIAL, CO 80111 PHONE: 303.721.0832

VICINITY MAP



LEGAL DESCRIPTIONS

STATE OF COLORADO

107 6TH AVE LOTS 1 AND 2 BLOCK 11 TOWN OF FRISCO, ACCORDING TO THE PLAT THEREOF RECORDED FEBRUARY 11, 1966 AS RECEPTION NO. 16089 **COUNTY OF SUMMIT** STATE OF COLORADO


STALEY HOUSE LOTS 3 AND 4 BLOCK 11 TOWN OF FRISCO, ACCORDING TO THE PLAT THEREOF RECORDED FEBRUARY 11, 1966 AS RECEPTION NO. 16089 **COUNTY OF SUMMIT**


FOOTE'S PROPERTY LOTS 5,6,7,8,9,10,11 AND 12 BLOCK 11 TOWN OF FRISCO, ACCORDING TO THE PLAT THEREOF RECORDED FEBRUARY 11, 1966 AS RECEPTION NO. 16089 **COUNTY OF SUMMIT** STATE OF COLORADO

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SCALE: NTS

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PROJECT 1300	SHEET 2	
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PROPOSED MODEL VIEWS	A0.3	
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MAIN STREET AND 6TH AVE PERSPECTIVE



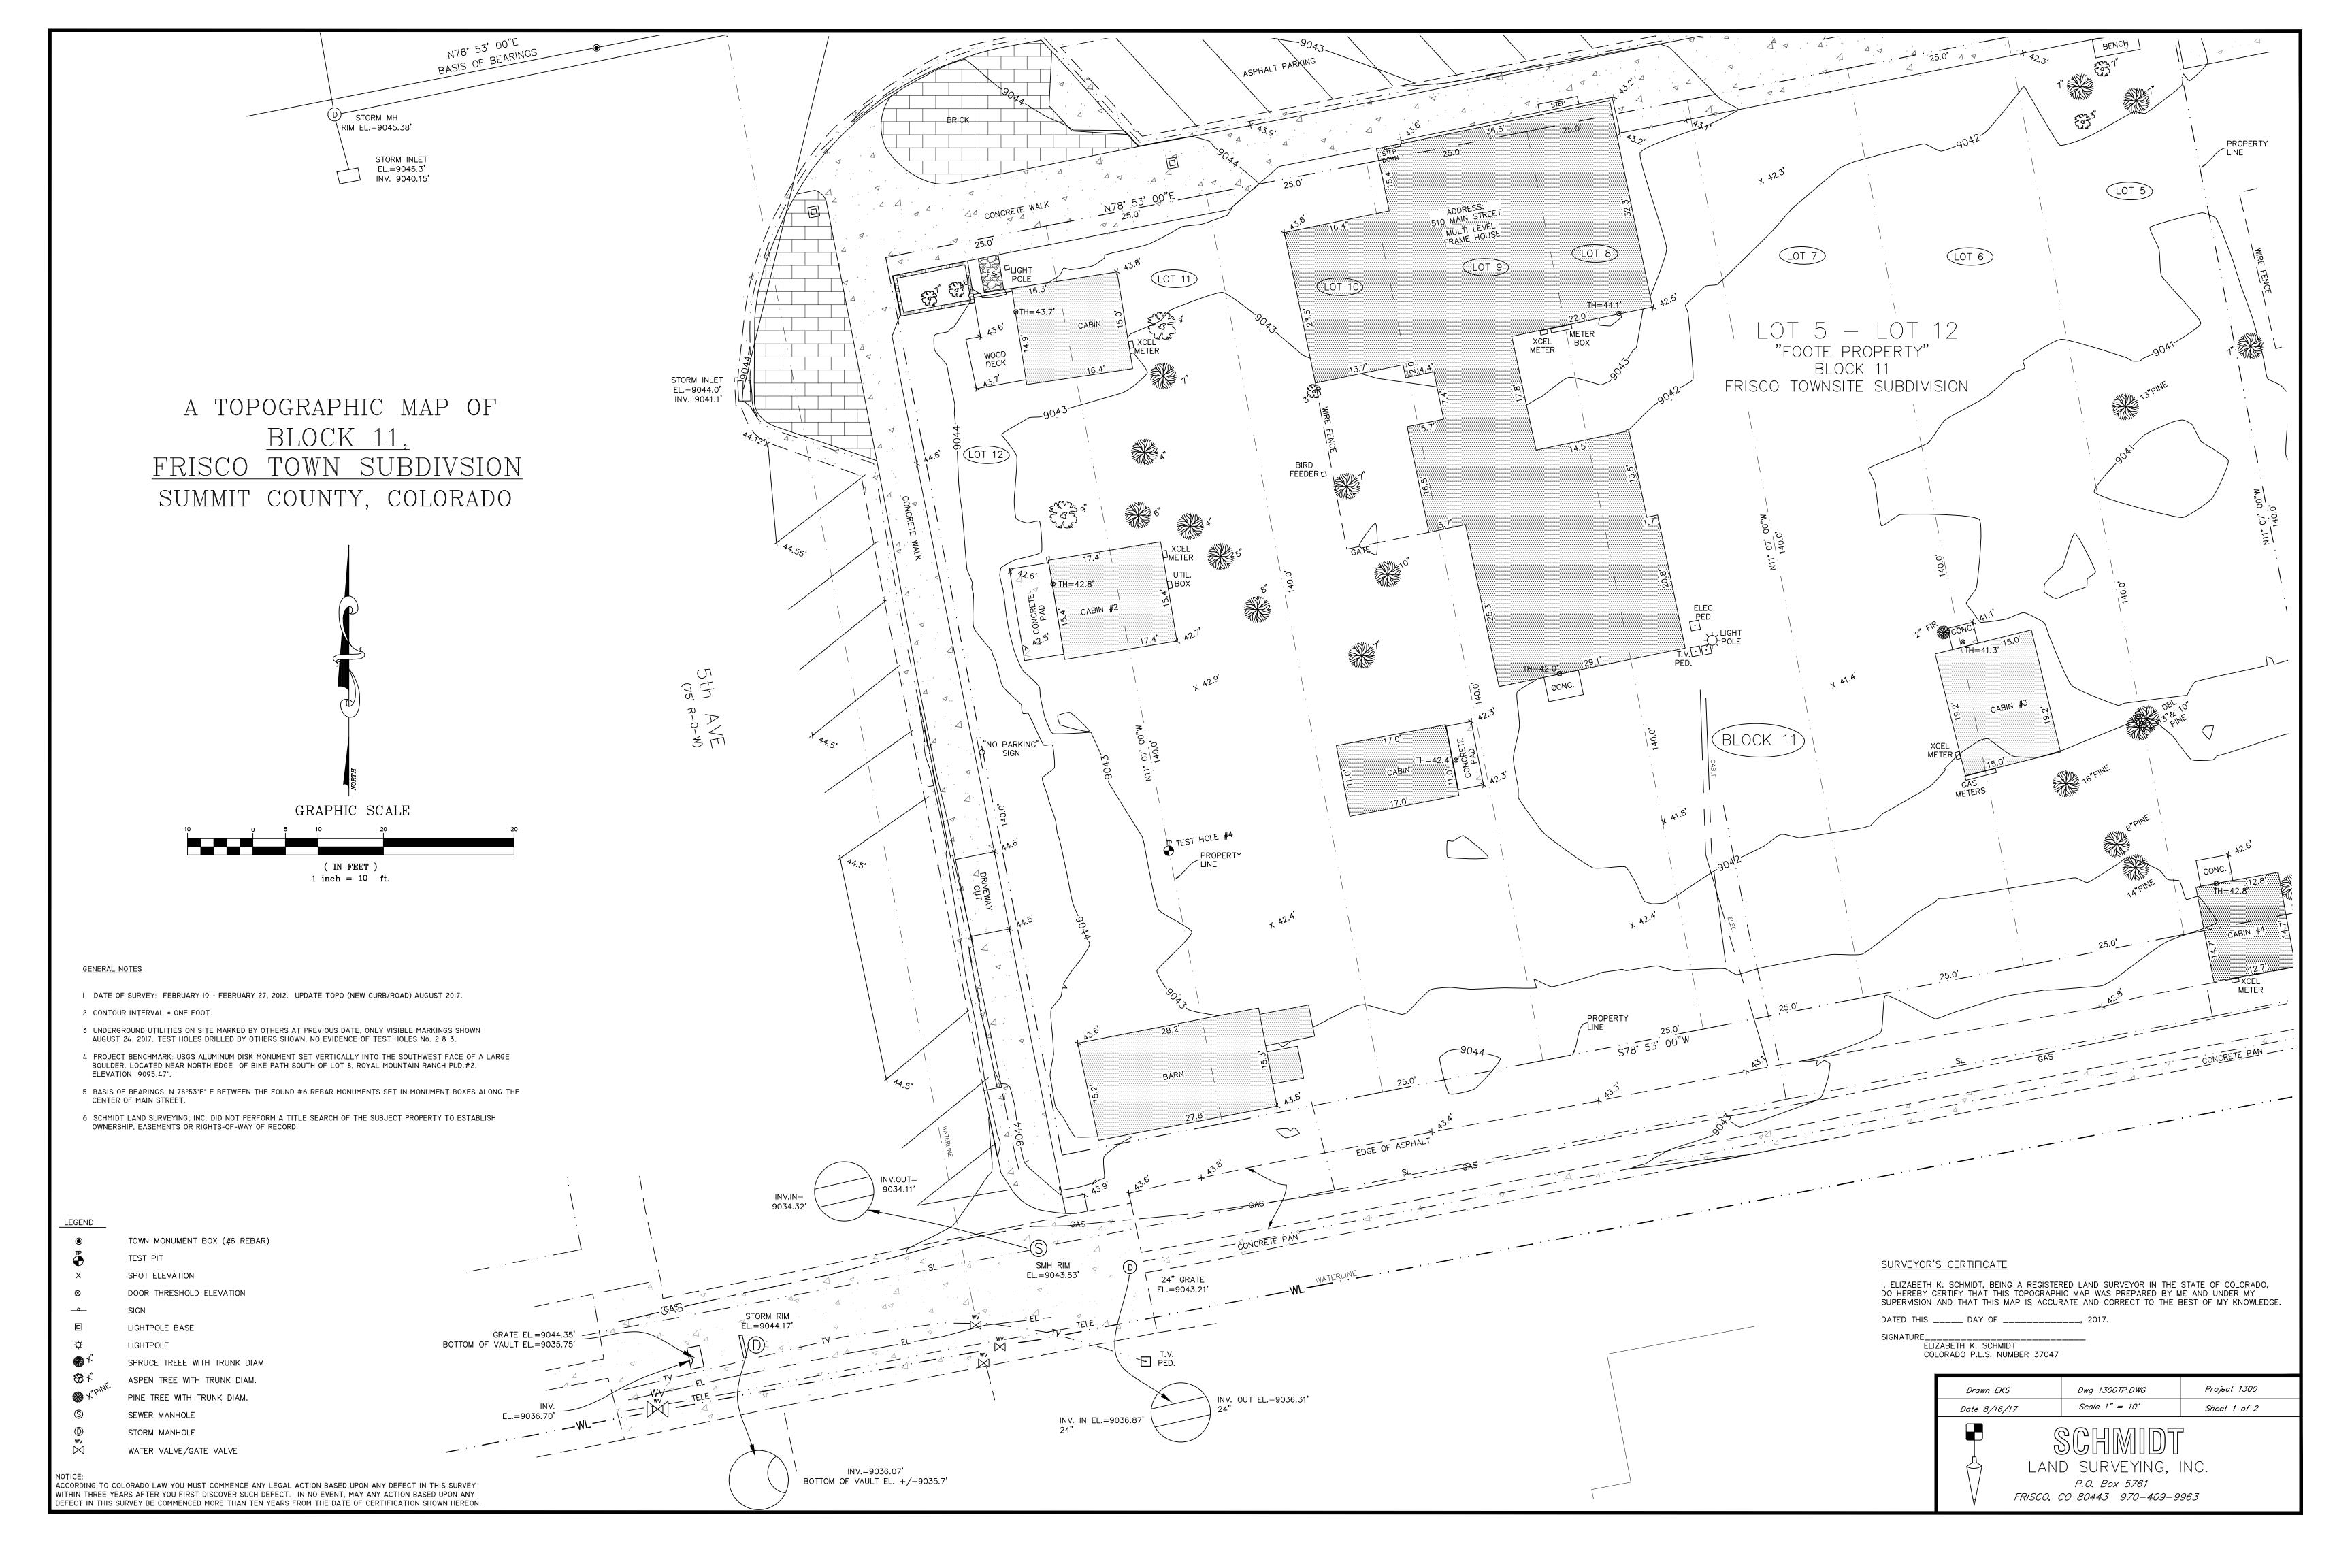

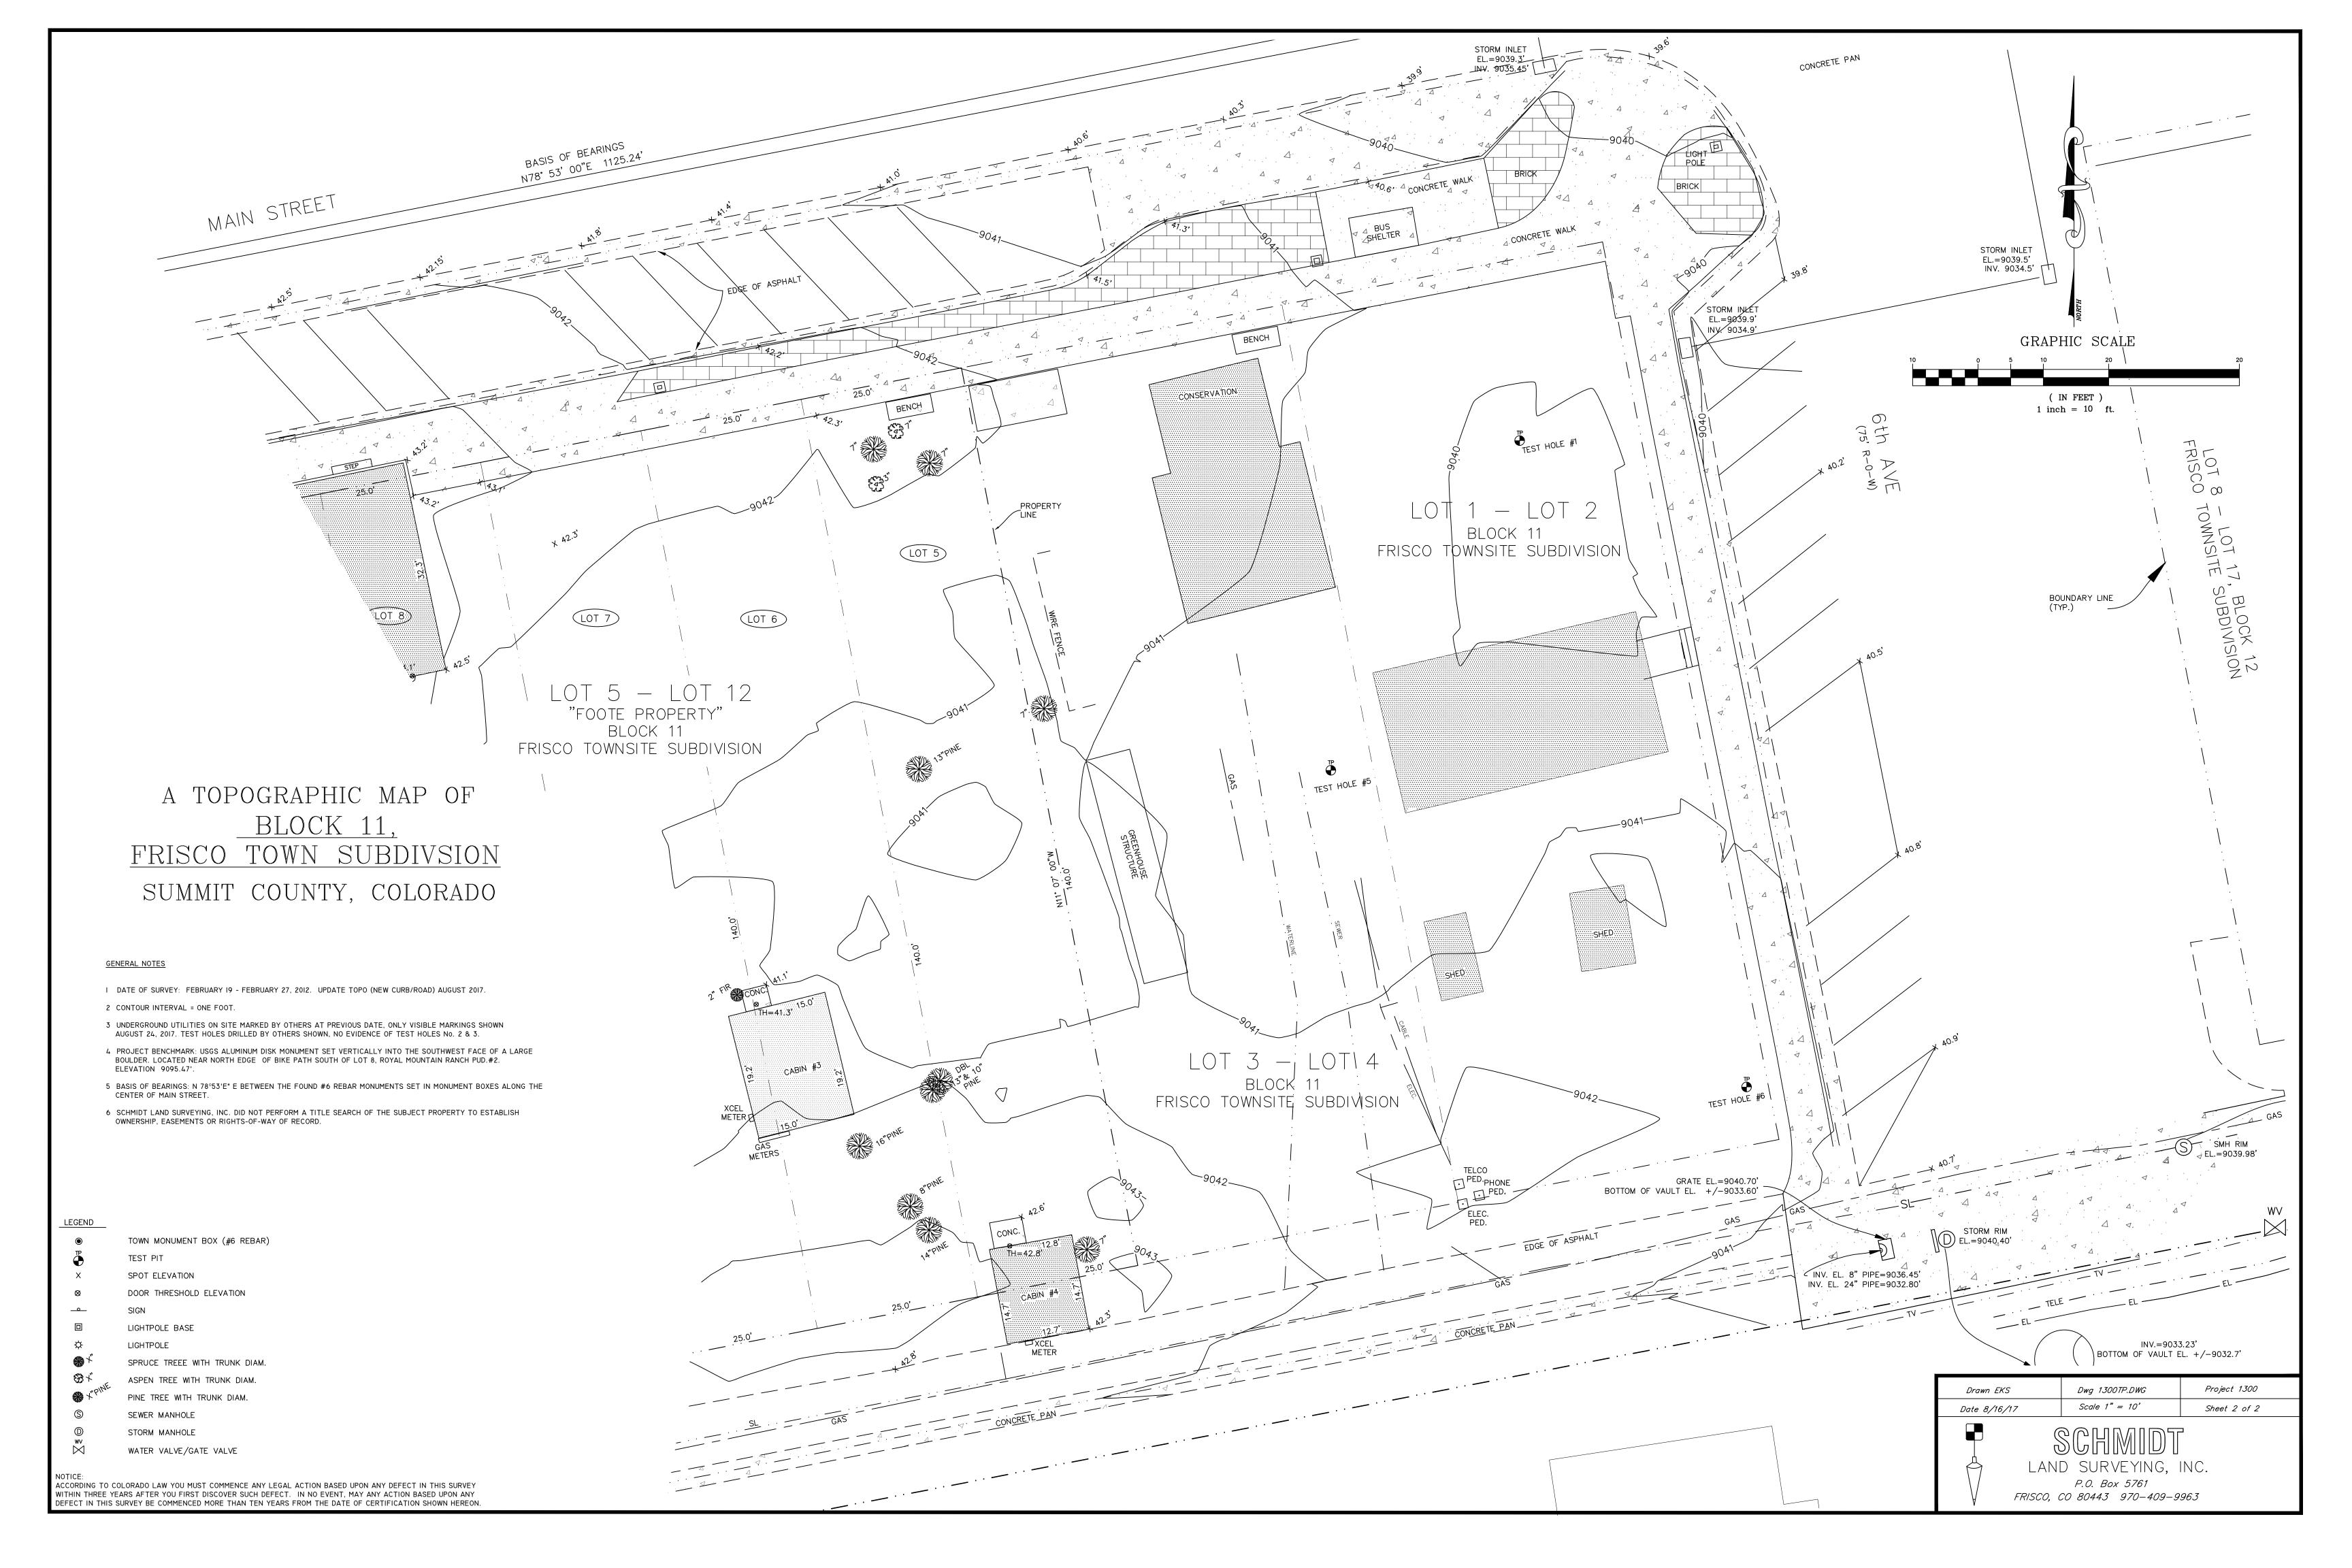5TH AVE AND MAIN STREET PERSPECTIVE

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234 e hopkins ave aspen, co 81611 denver, co 80202 970.544.9006 o 303.308.1373 o 970.544.3473 f 303.308.1375 f

Consultants

Issue:
2017.05.15
SKETCH PLAN REVIEW &
HISTORIC DISTRICT OVERLAY
REZONE
2017.06.28
SKETCH PLAN REVIEW &
HISTORIC DISTRICT OVERLAY
REZONE - REVISION
2017.08.16
DEV. APPLICATION PRE-APP MTG
2017.09.06

DEV. APPLICATION & HISTORIC DISTRICT OVERLAY REZONE

FOOTES REST

BLOCK 11 500 MAIN STREET FRISCO, CO 80443

PROJECT NO:
21707
DWG FILE:
21707_A0-1_Model Views_ALT.dwg

PROPOSED MODEL VIEWS
SCALE: NTS

A0.1







AL FRESCO DINNING ALONG MAIN STREET PERSPECTIVE





PUBLIC PLAZA HOTEL AND FOOTE'S REST SWEETS SHOP PERSPECTIVE

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FOOTES REST

BLOCK 11 500 MAIN STREET FRISCO, CO 80443

PROJECT NO: 21707 DWG FILE: 21707_A0-1_Model Views_ALT.dwg

PROPOSED MODEL VIEWS
SCALE: NTS

A0 2

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PUBLIC PLAZA PERSPECTIVE



PUBLIC PLAZA PERSPECTIVE



COURTYARD PERSPECTIVE



PUBLIC PLAZA PERSPECTIVE

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FOOTES REST


BLOCK 11 500 MAIN STREET FRISCO, CO 80443

PROJECT NO: 21707 DWG FILE: 21707_A0-1_Model Views_ALT.dwg

PROPOSED MODEL VIEWS
SCALE: NTS

A0.3


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BRICK - MAROON, BROWN AND GREY BLEND (ROBINSON BRICK OR SIMILAR)

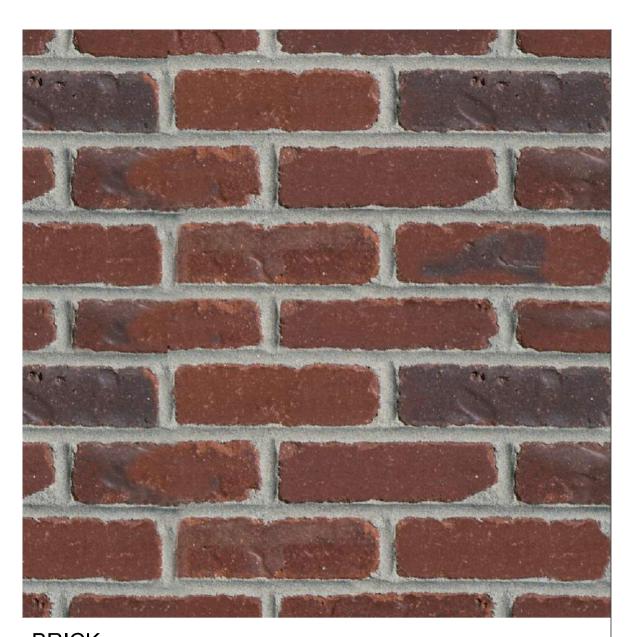

VERTICAL T&G/SHIPLAP SIDING - VARIOUS WOOD TONES (LIGHT AND DARK) - 4" EXPOSURE



HORIZONTAL LAP / SHIPLAP SIDING - VARIOUS WOOD TONES (LIGHT AND DARK) - 4" EXPOSURE

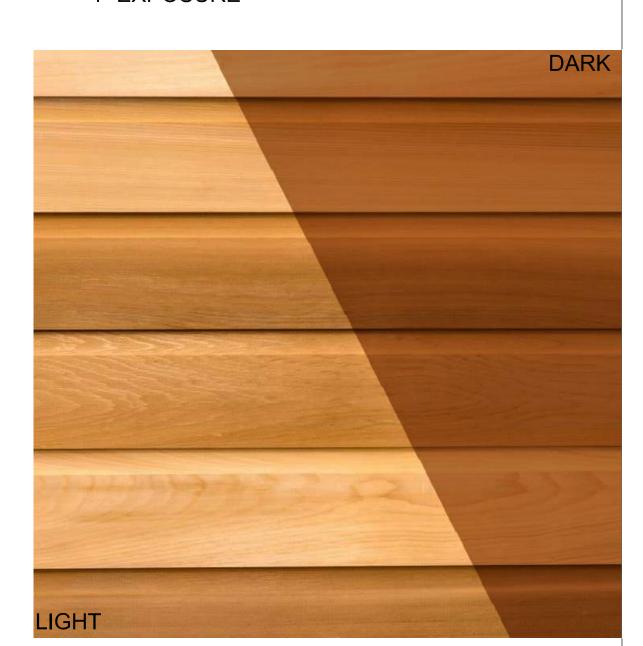


STANDING SEAM ROOF -DARK GREY



DARK BRAKE METAL TRIM - FASCIA, GUTTERS, DOWNSPOUTS, ETC (BARRIDGE OR SIM)



EXPOSED STEEL-LOOK TRIM DETAILS - DARK METAL TONE

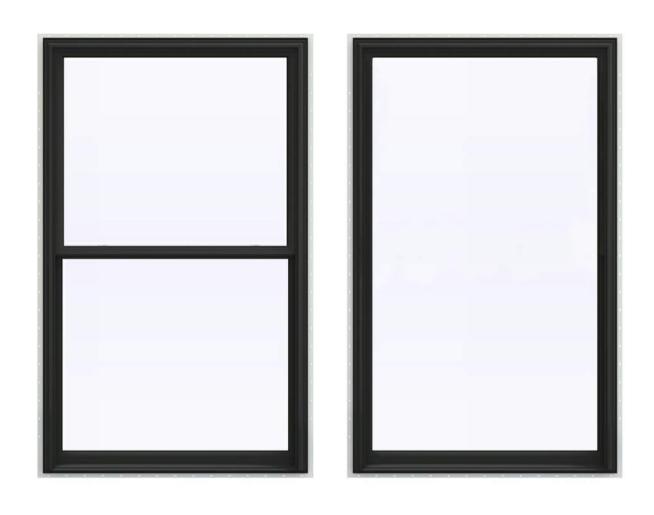


DOUBLE HUNG, CASEMENT, AND FIXED WINDOWS -DARK EXTERIOR (MILGARD, MARVIN, JELDWEN, OR SIM.)




MOVABLE GLASS PANEL WALL -DARK EXTERIOR WITH NARROW SIGHT LINES (NANA WALL OR SIM.)



CABLE OR METAL BAR GUARD RAIL -(DARK METAL)

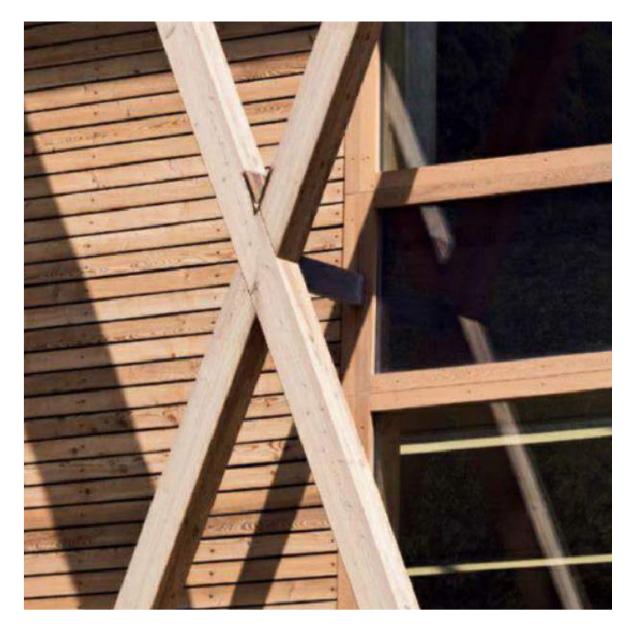

DECORATIVE TIMBER TRIM DETAILS - VARIOUS STAINS (LIGHT & DARK)

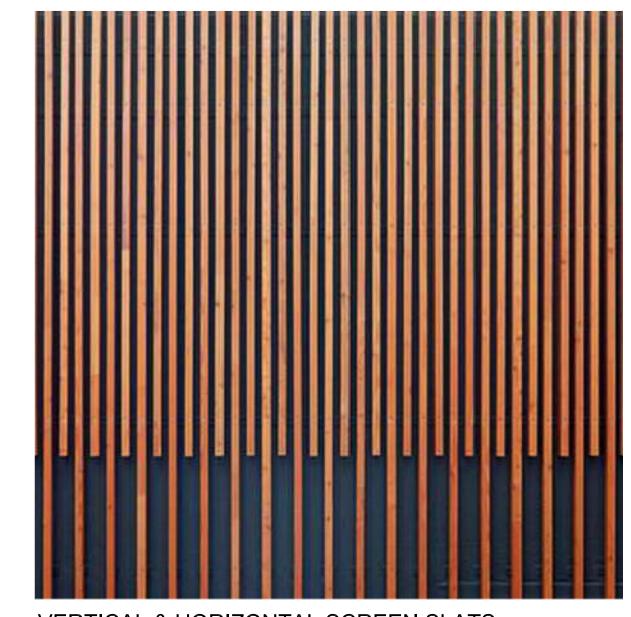

VERTICAL & HORIZONTAL SCREEN SLATS - LIGHT WOOD TONES - VARIOUS SIZES



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2017.05.15

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2017.08.16 DEV. APPLICATION PRE-APP MTG

2017.09.06 DEV. APPLICATION & HISTORIC DISTRICT OVERLAY REZONE

FOOTES REST


BLOCK 11 500 MAIN STREET FRISCO, CO 80443

PROJECT NO: 21707 DWG FILE: 21707_A0-3.dwg

SHEET TITLE

PROPOSED **MATERIALS**

SCALE: NTS

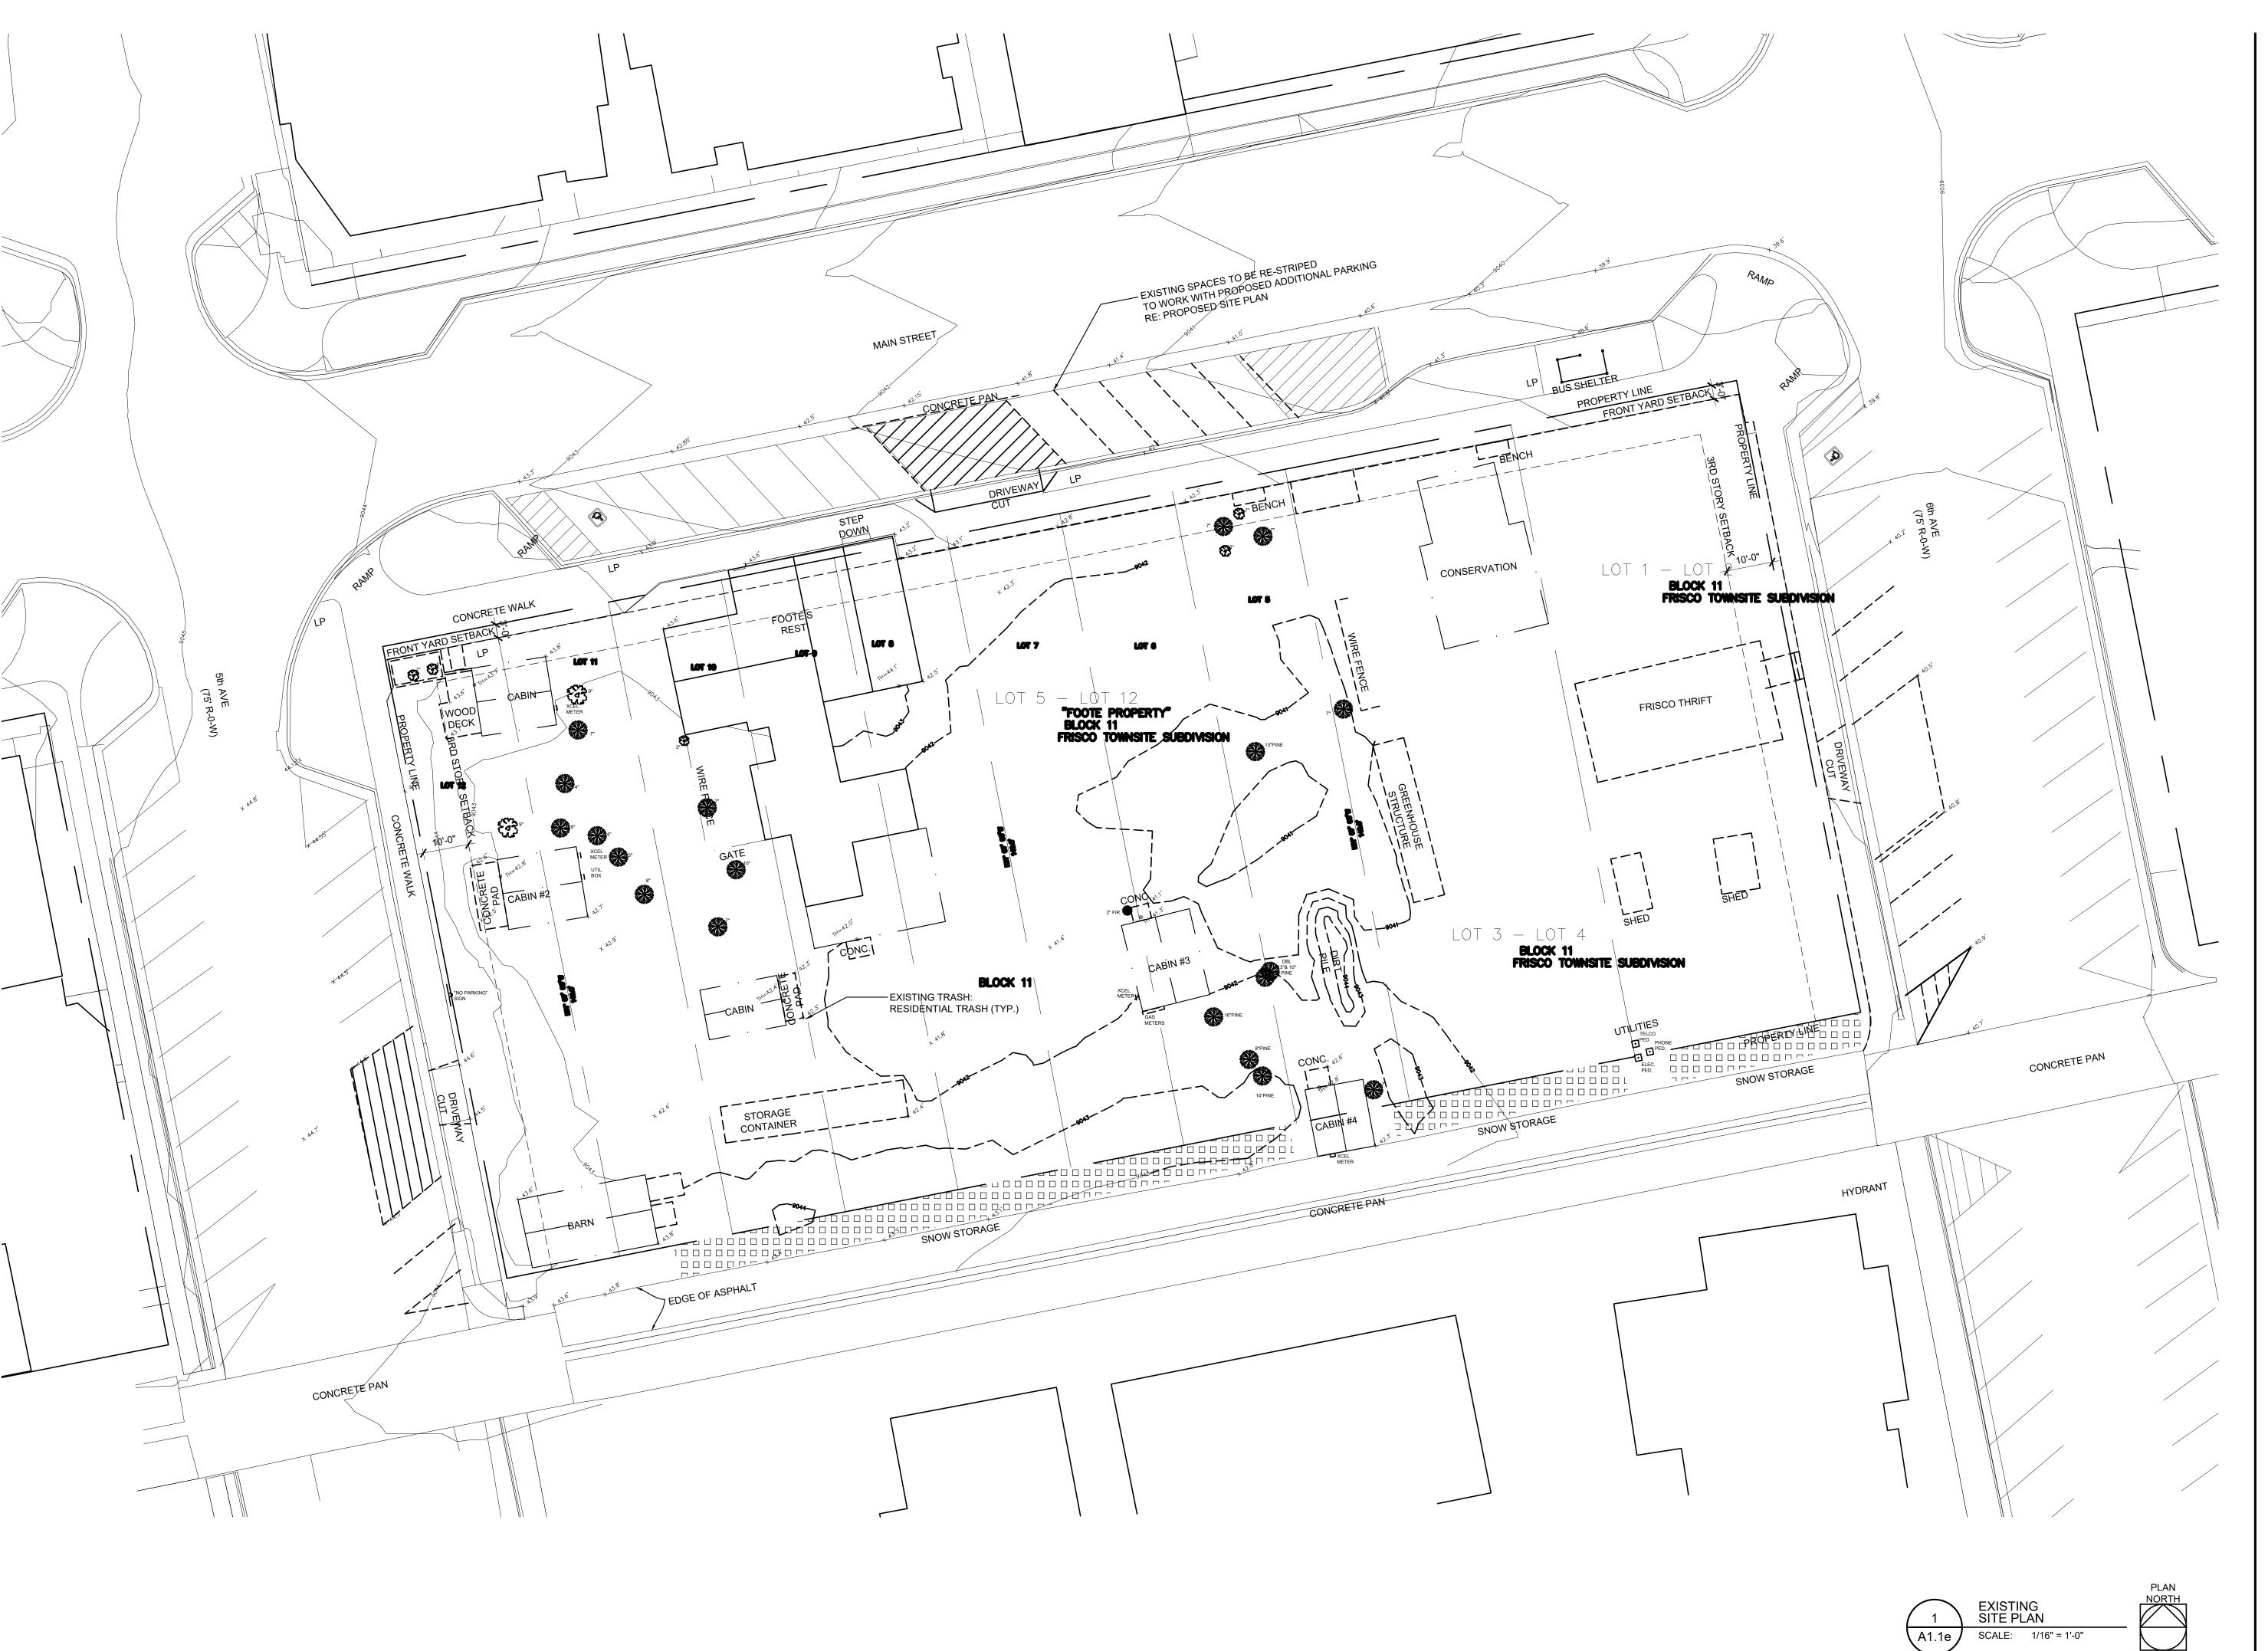



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2017.09.06
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DISTRICT OVERLAY REZONE

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PROJECT NO: 21707 DWG FILE: 21707_D1-1.dwg


SHEET TITLE

FXISTIN

EXISTING SITE PLAN

SCALE: 1/16"=1'-0"

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PROPOSED HISTORIC OVERLAY
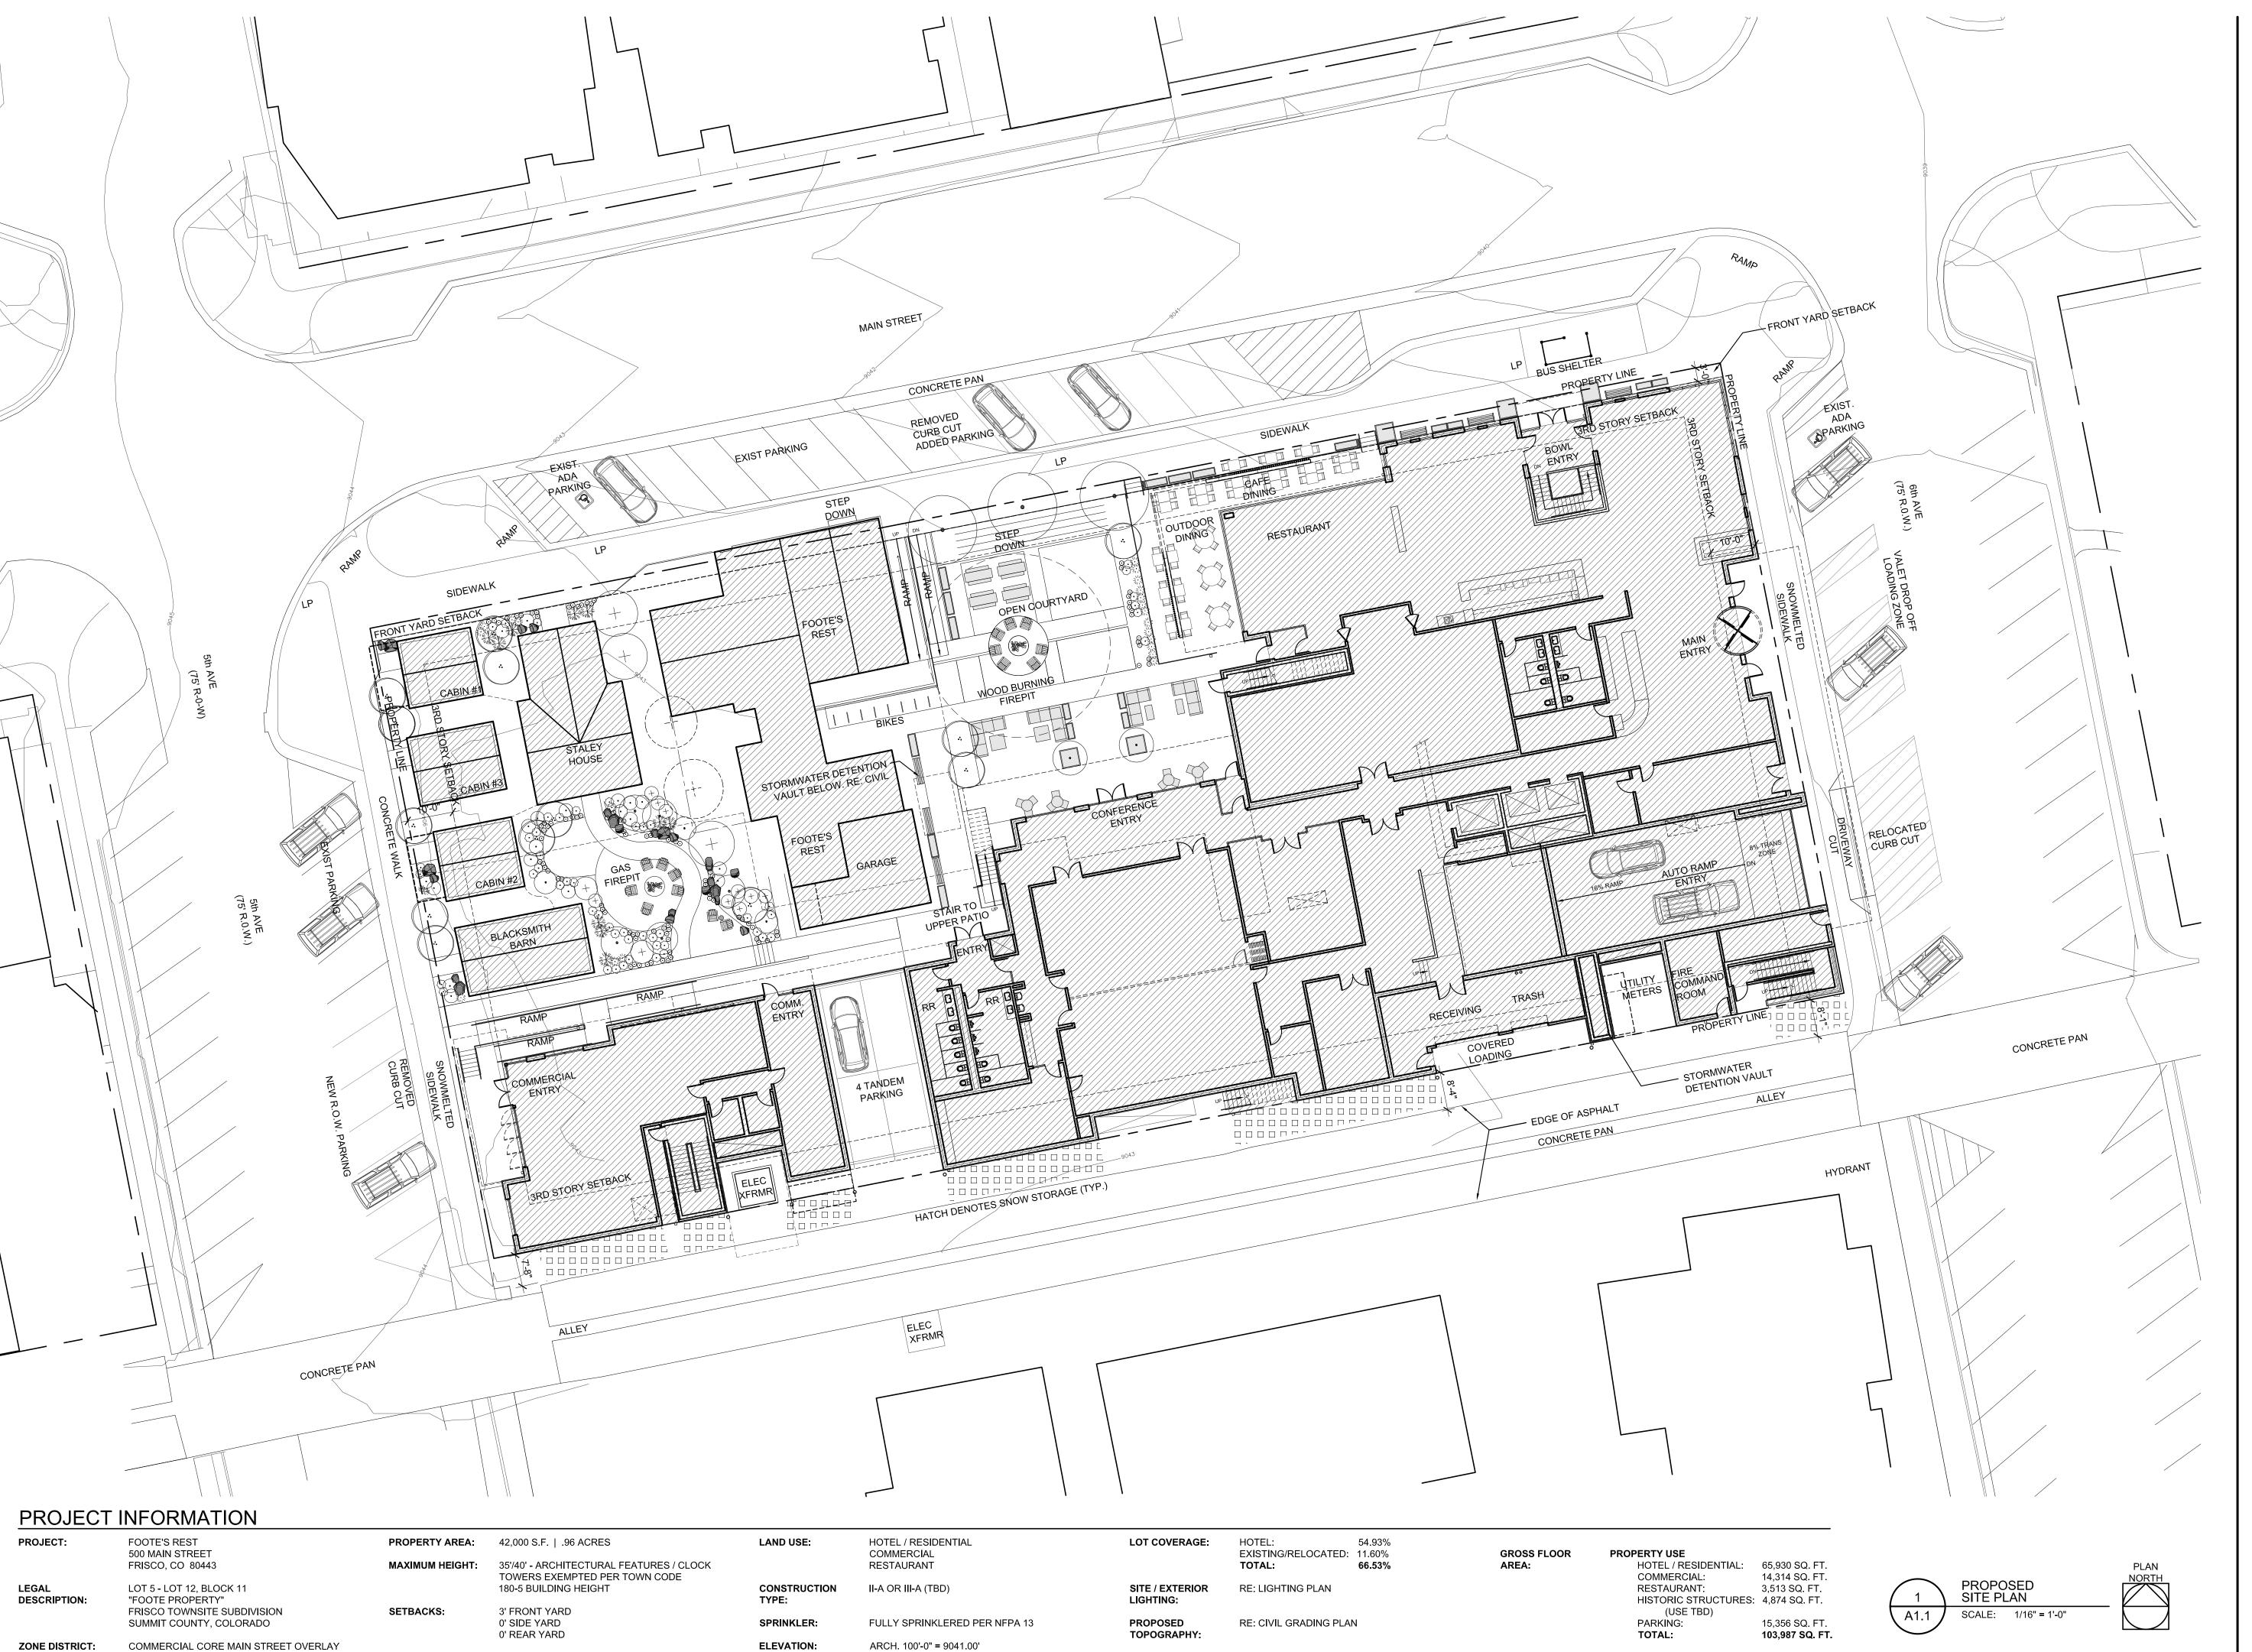
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2017.05.15

2017.11.03

970.544.9006 o 970.544.3473 f

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- COMMENTS RESPONSE

FOOTES REST

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SHEET TITLE

PROPOSED SITE PLAN

SCALE: 1/16"=1'-0"

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DISTRICT OVERLAY REZONE
- COMMENTS RESPONSE

2017.11.03

FOOTES REST

BLOCK 11 500 MAIN STREET FRISCO, CO 80443


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SHEET TITLE

PROPOSED
BUILDING HEIGHT
CALCULATIONS
SCALE: 1/16"=1'-0"

A1.2

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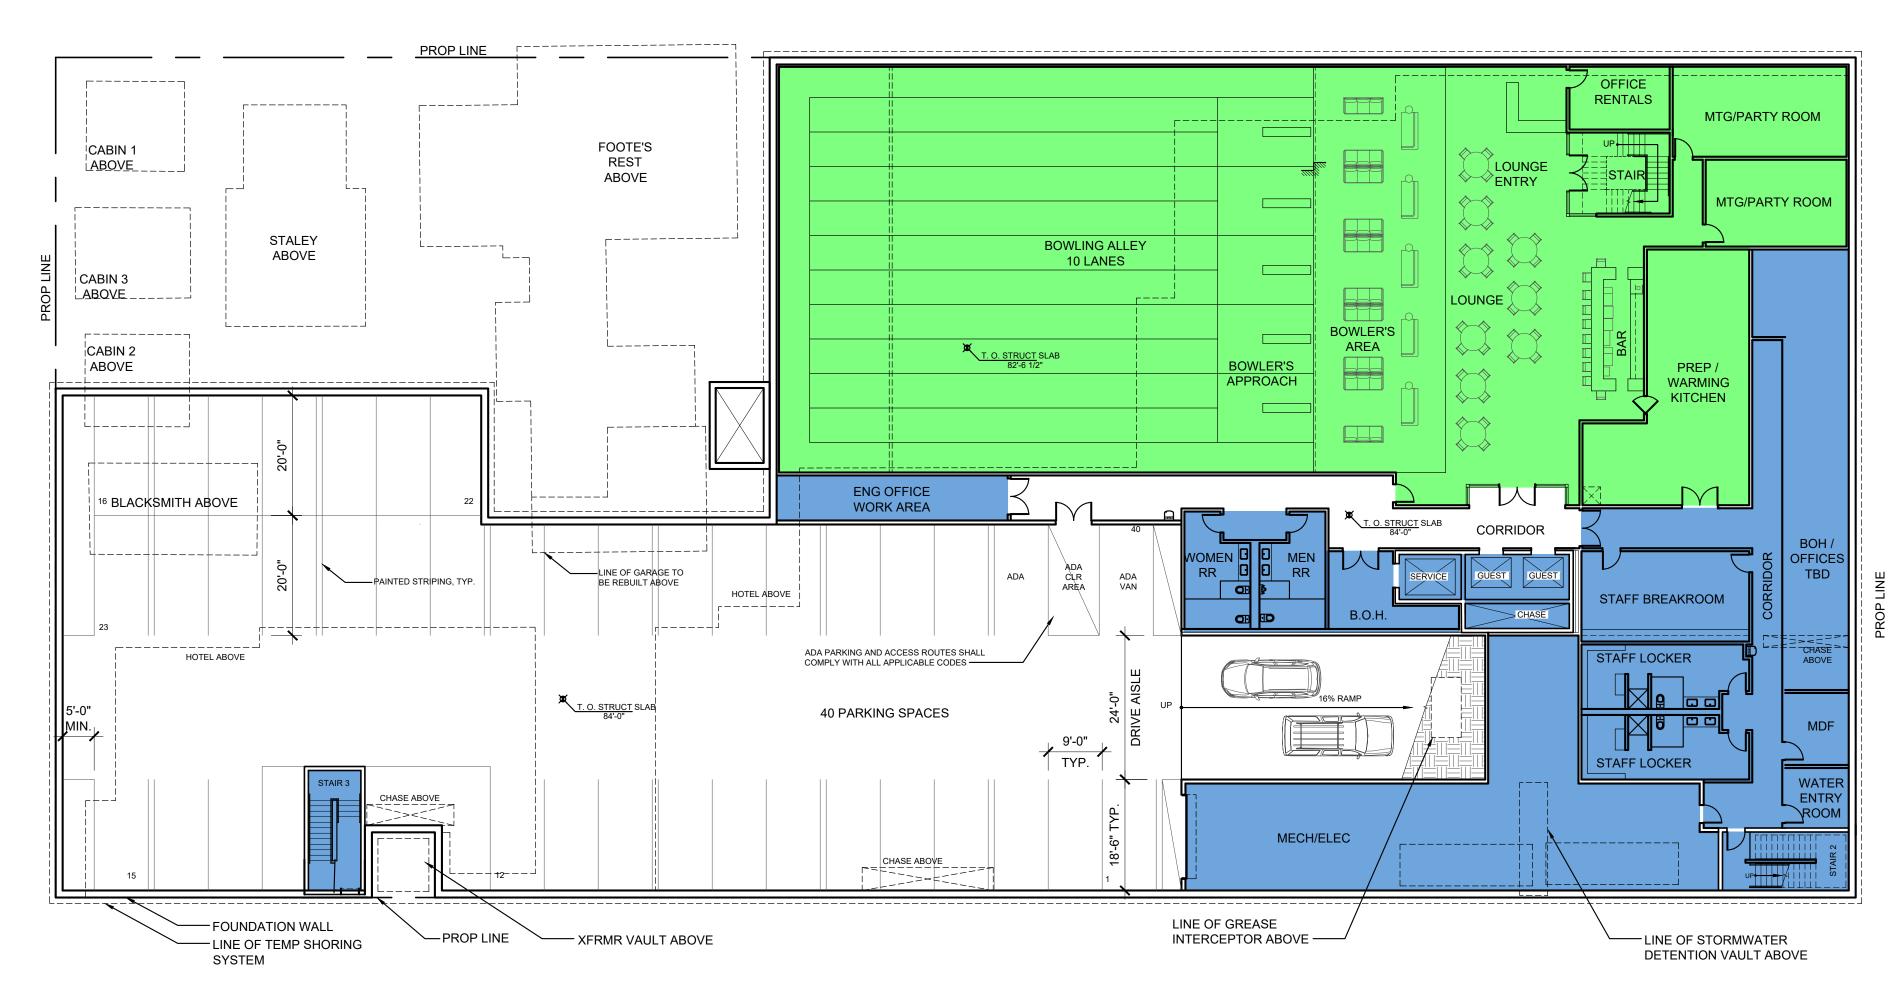
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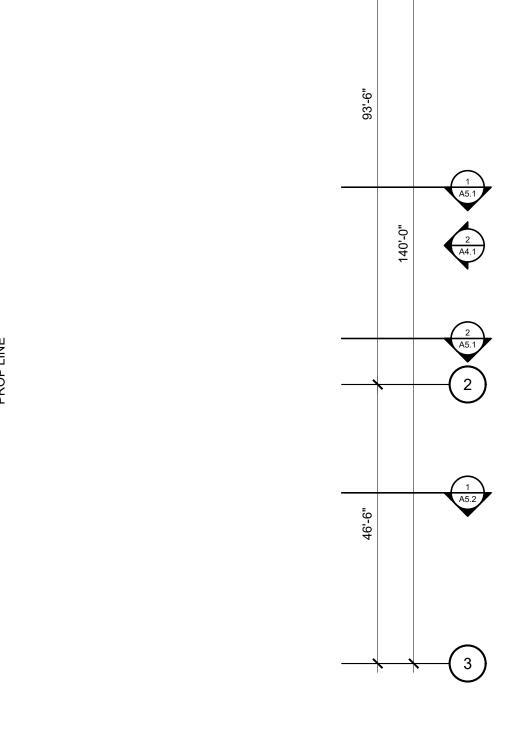
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SHEET TITLE

PROPOSED **BASEMENT FLOOR PLAN**

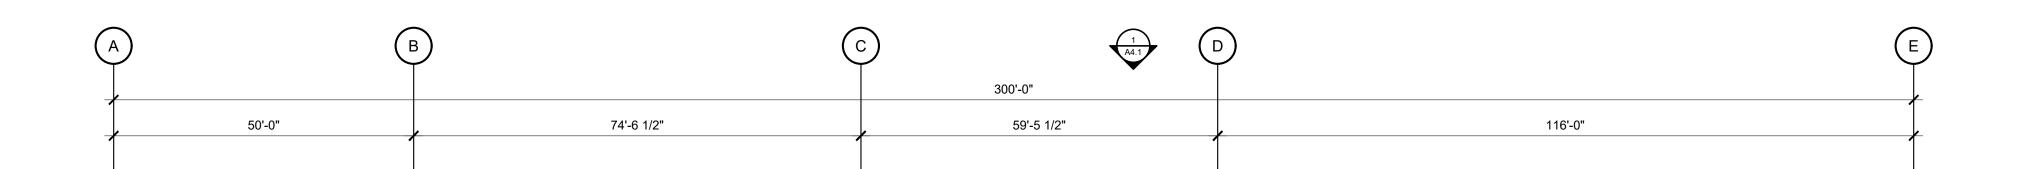
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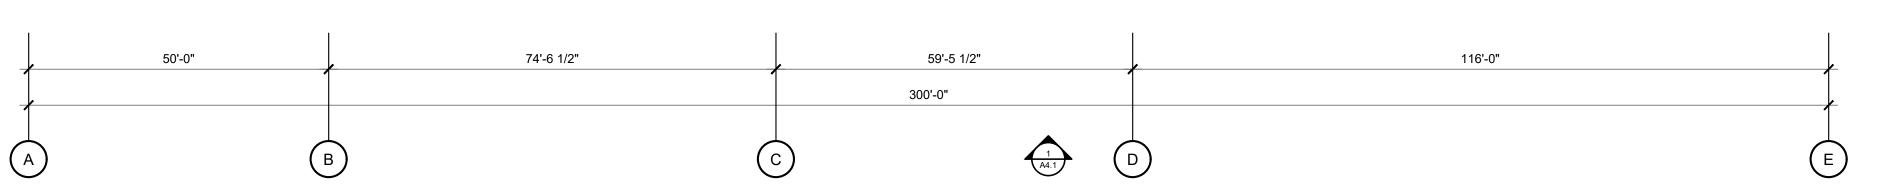





PROPOSED BASEMENT FLOOR PLAN


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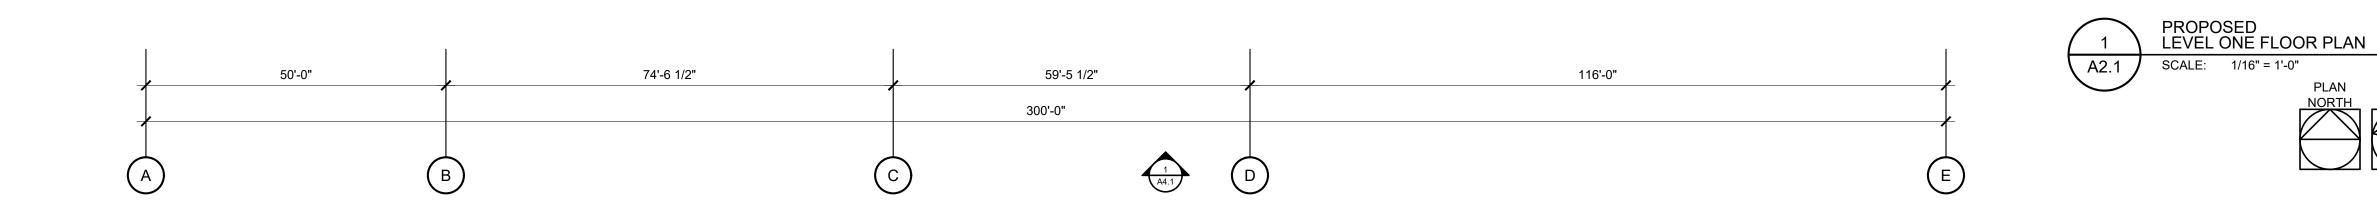


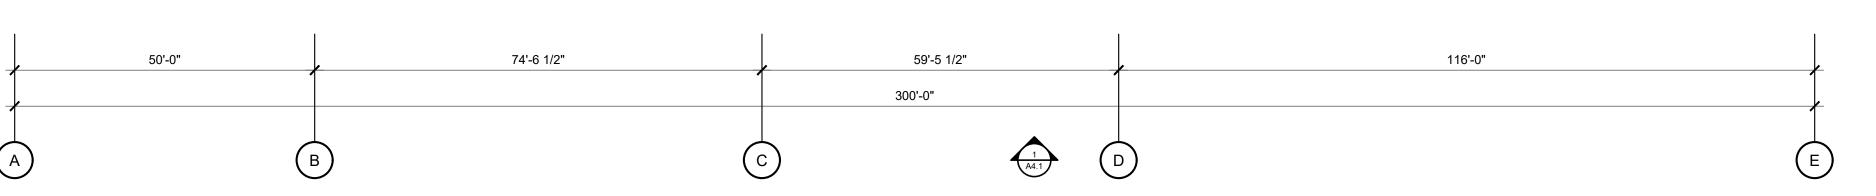


1 A5.2



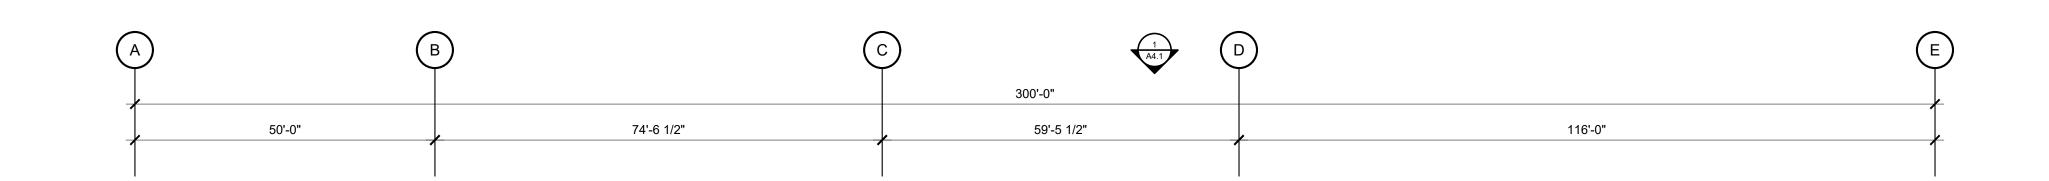

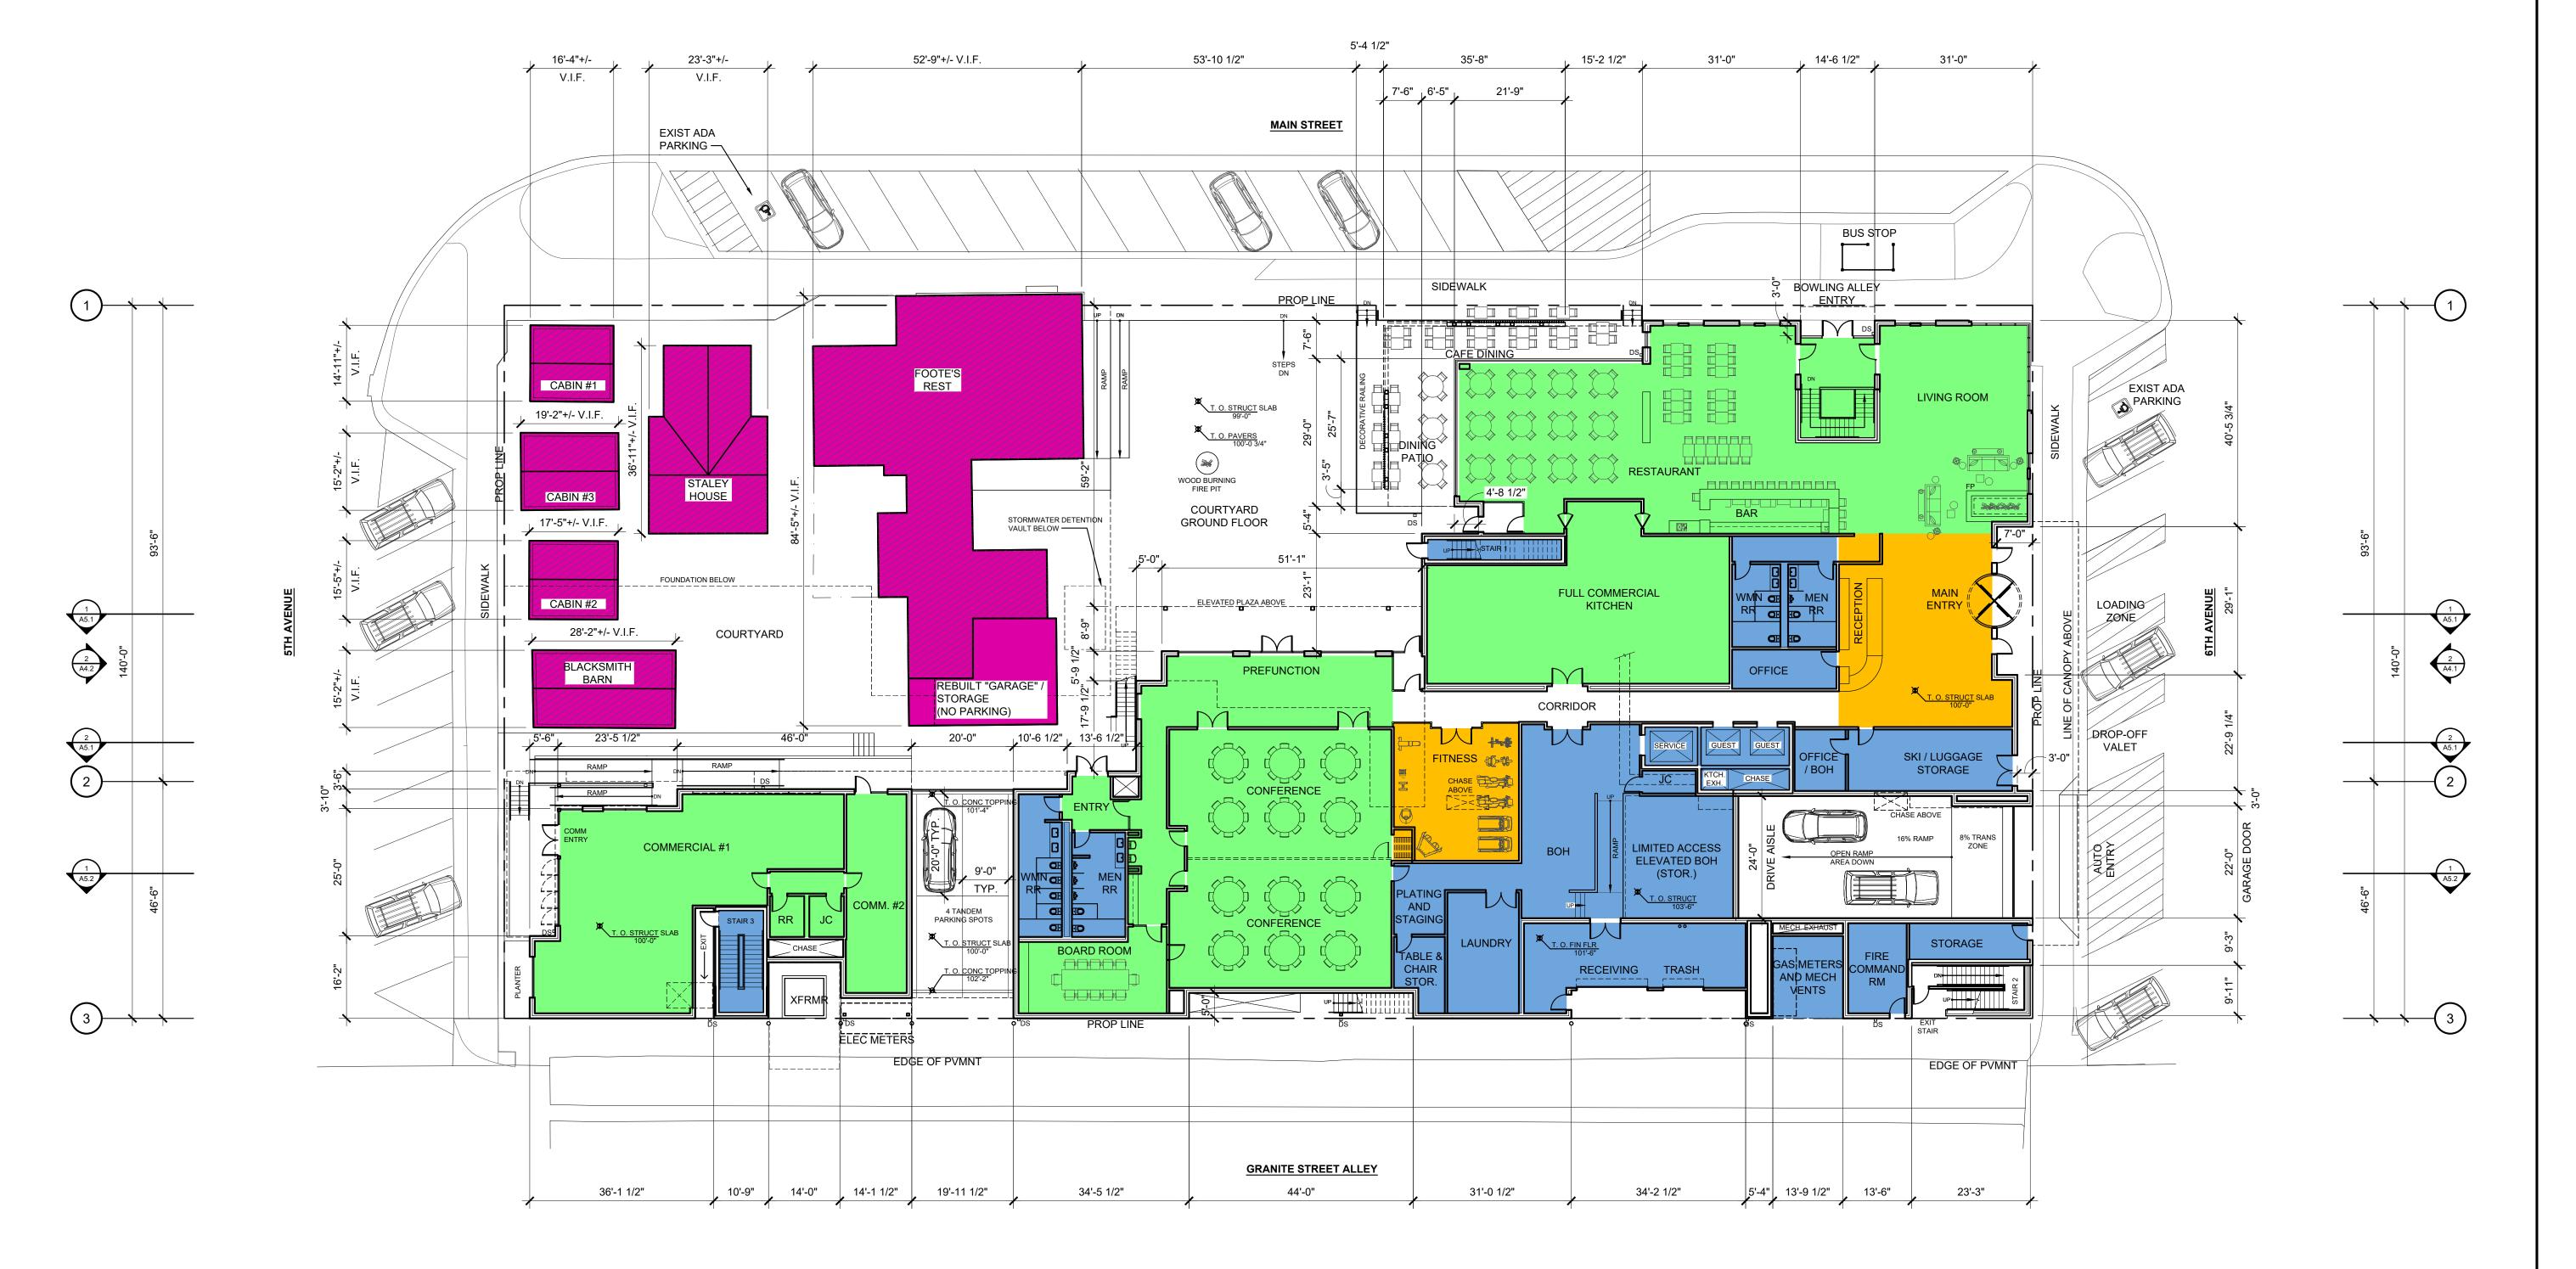

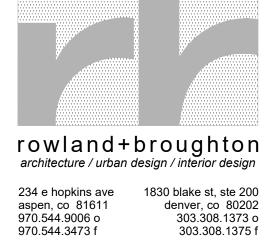

denver, co 80202 303.308.1373 o 303.308.1375 f

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FOOTES REST


BLOCK 11 **500 MAIN STREET** FRISCO, CO 80443

PROJECT NO: 21707 DWG FILE: 21707_A2-1.dwg

SHEET TITLE

PROPOSED LEVEL ONE FLOOR PLAN

SCALE: 1/16"=1'-0"

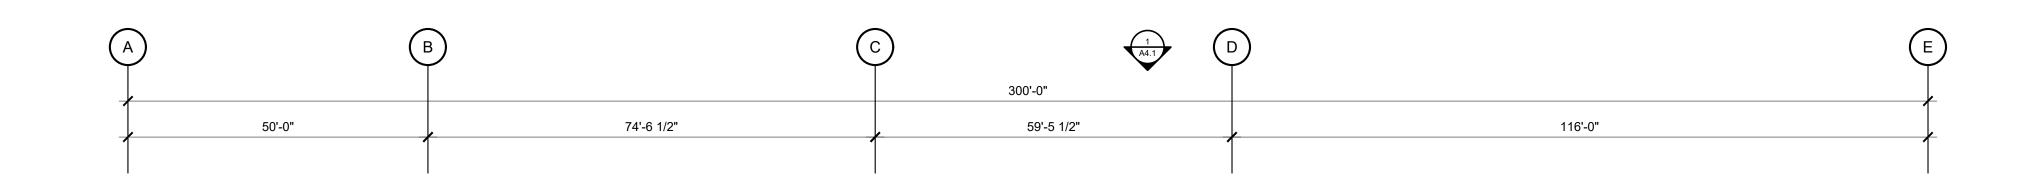



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FOOTES REST

BLOCK 11 500 MAIN STREET FRISCO, CO 80443

PROJECT NO: 21707 DWG FILE: 21707_A2-2.dwg

PROPOSED LEVEL TWO FLOOR PLAN

A2.2

116'-0"

PROPOSED LEVEL TWO FLOOR PLAN

SCALE: 1/16"=1'-0"

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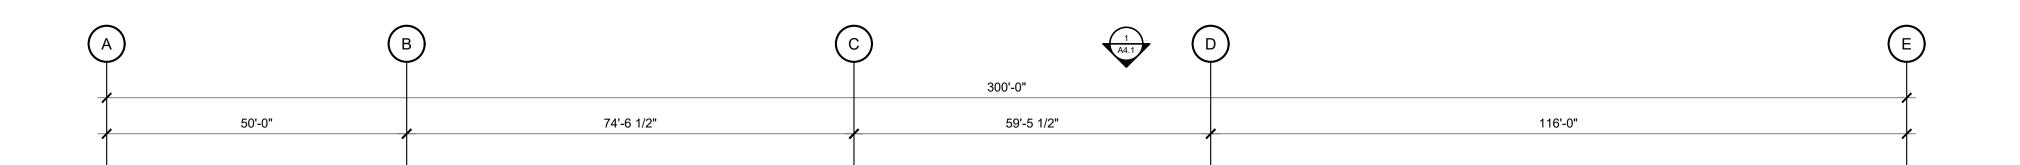


59'-5 1/2"

300'-0"

50'-0"

74'-6 1/2"





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DEV. APPLICATION & HISTORIC DISTRICT OVERLAY REZONE - COMMENTS RESPONSE

FOOTES REST

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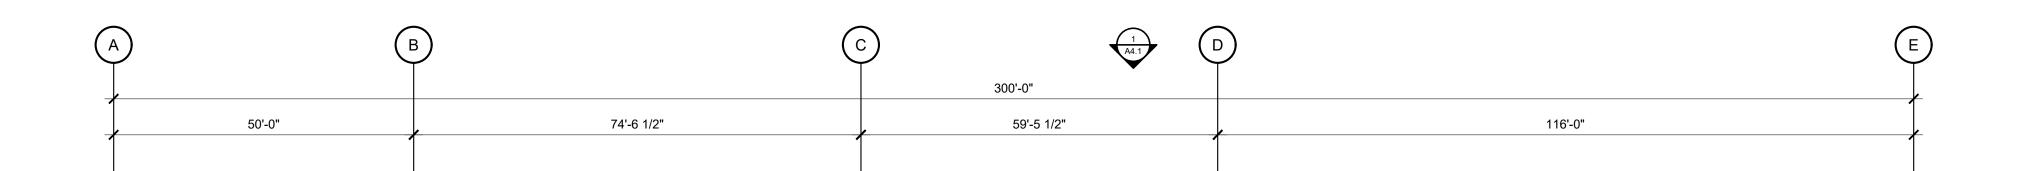
SHEET TITLE

PROPOSED LEVEL THREE FLOOR PLAN

SCALE: 1/16"=1'-0"

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2017.11.03

DEV. APPLICATION & HISTORIC DISTRICT OVERLAY REZONE
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FOOTES REST

BLOCK 11 500 MAIN STREET FRISCO, CO 80443

PROJECT NO: 21707 DWG FILE: 21707_A2-4.dwg

SHEET TITLE

FOR FURTHER BUILDING HEIGHT INFORMATION

EXCLUDED FROM BLDG HGT CALCS PER TOWN

DISCUSSION ON CLOCK TOWER/ARCHITECTURAL

PROPOSED ROOF DECK FLOOR PLAN

1/16" = 1'-0"

TRUE

PLAN

2. MECHANICAL EQUIPMENT AND SCREENS

3. REFER TO DEVELOPMENT NARRATIVE FOR

CODE 180-5 BLDG HEIGHT

FEATURE.

A2.4


116'-0"

PROPOSED ROOF DECK FLOOR PLAN

SCALE: 1/16"=1'-0"

Δ24

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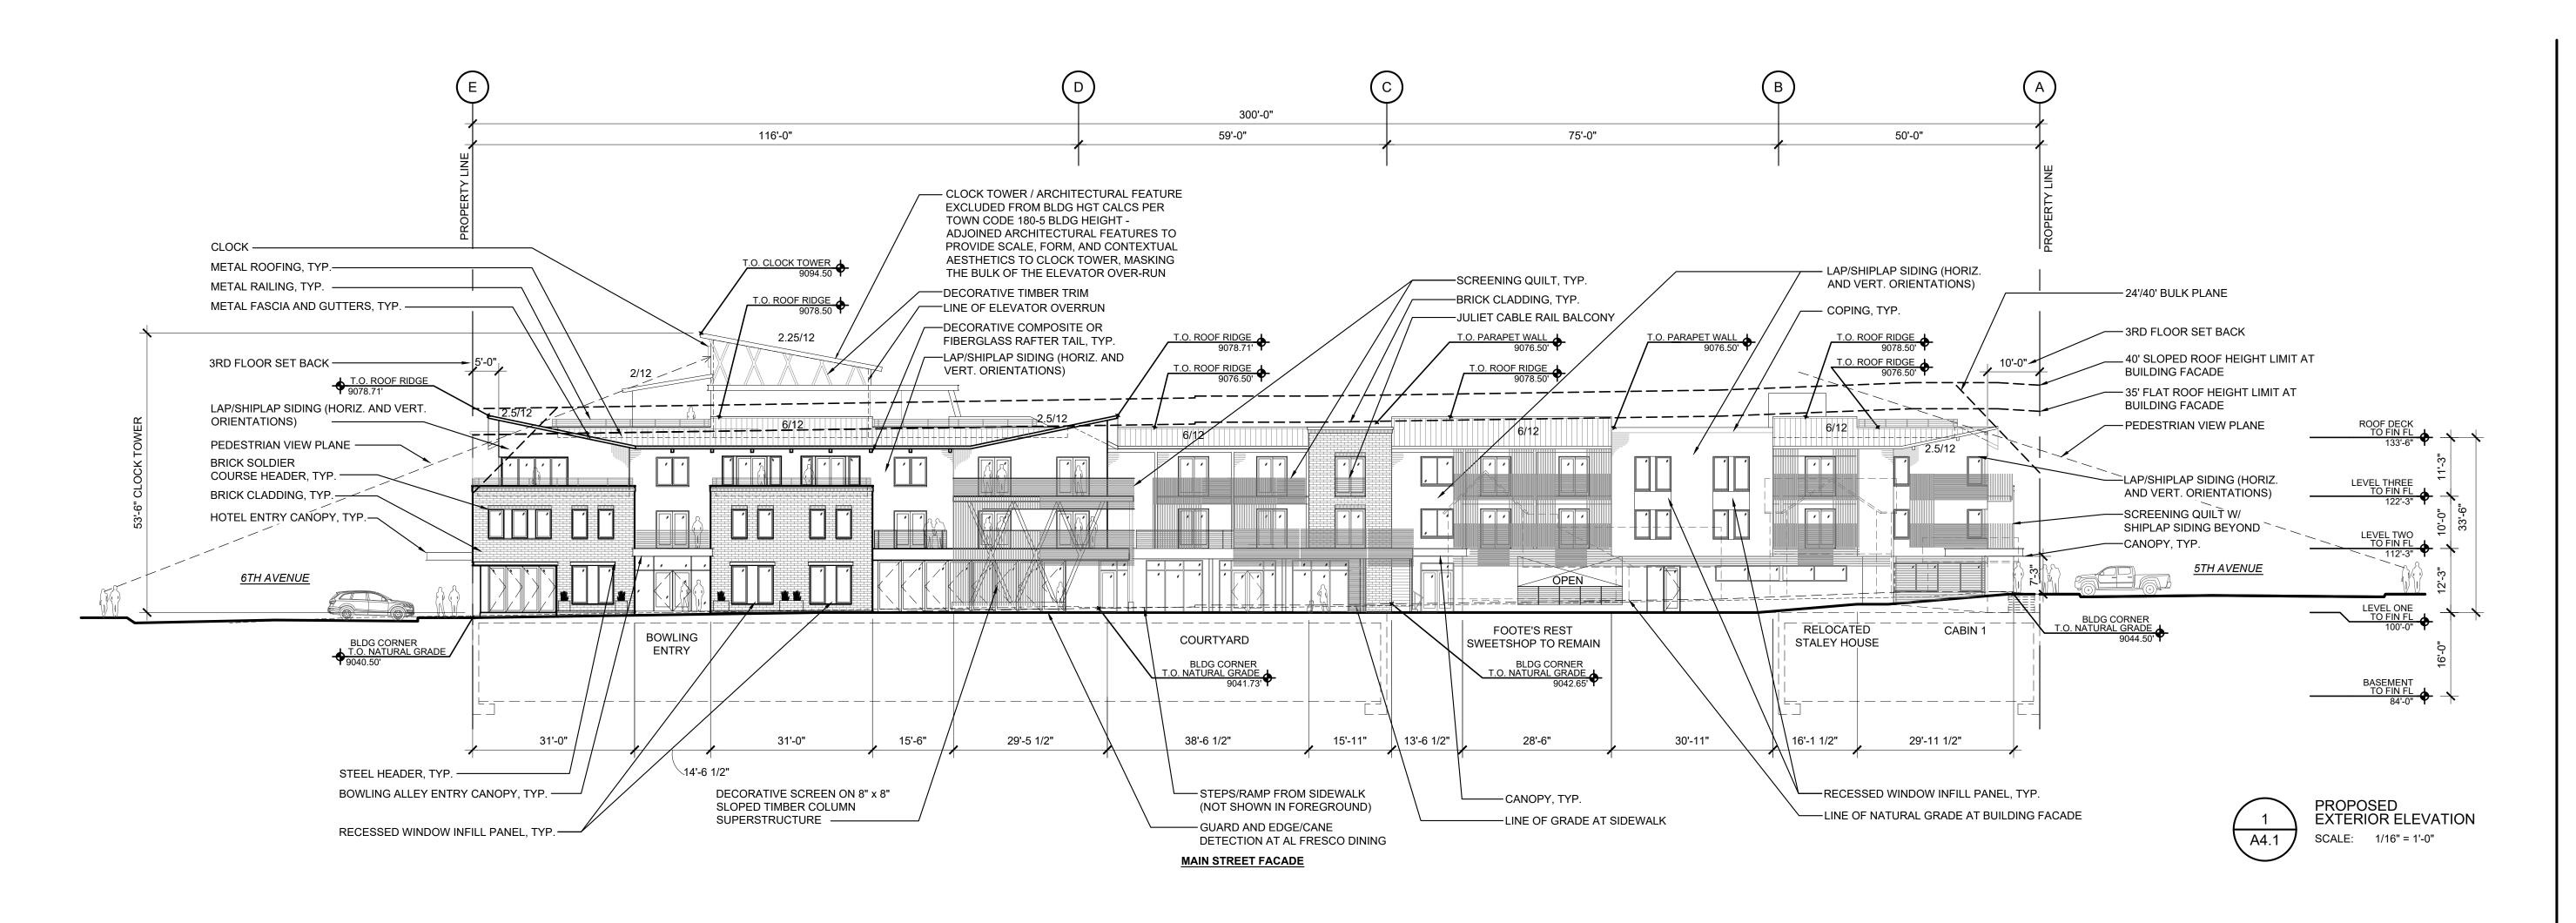


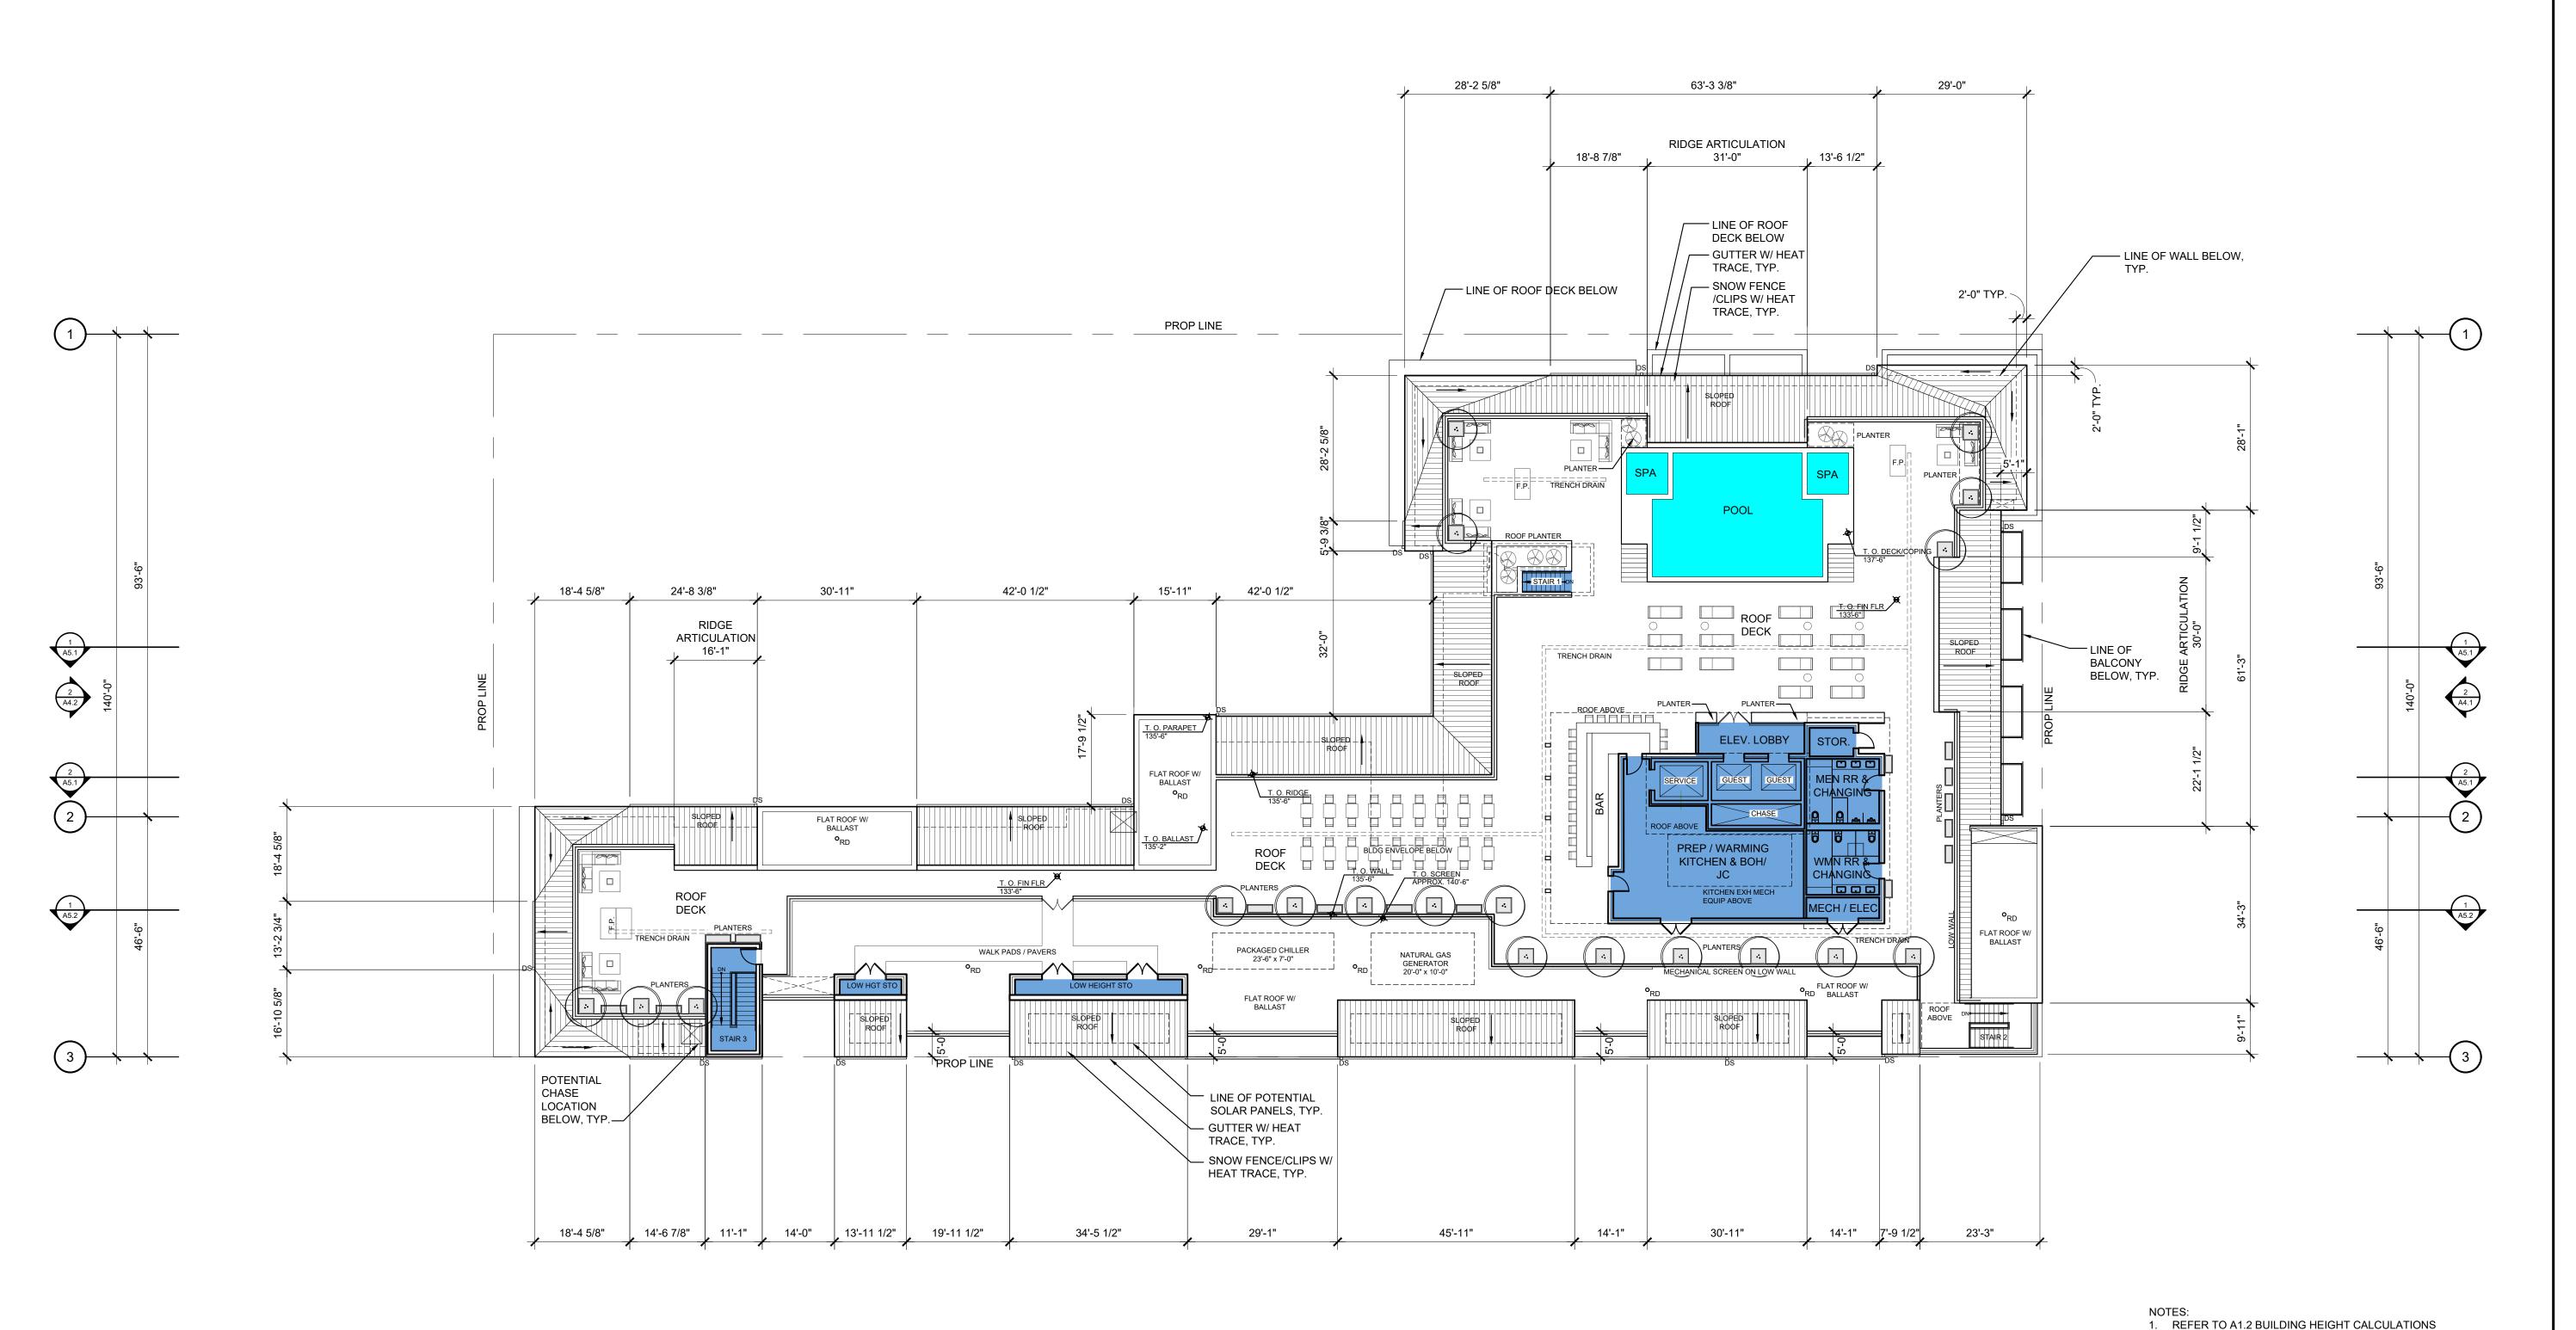
59'-5 1/2"

300'-0"

50'-0"

74'-6 1/2"



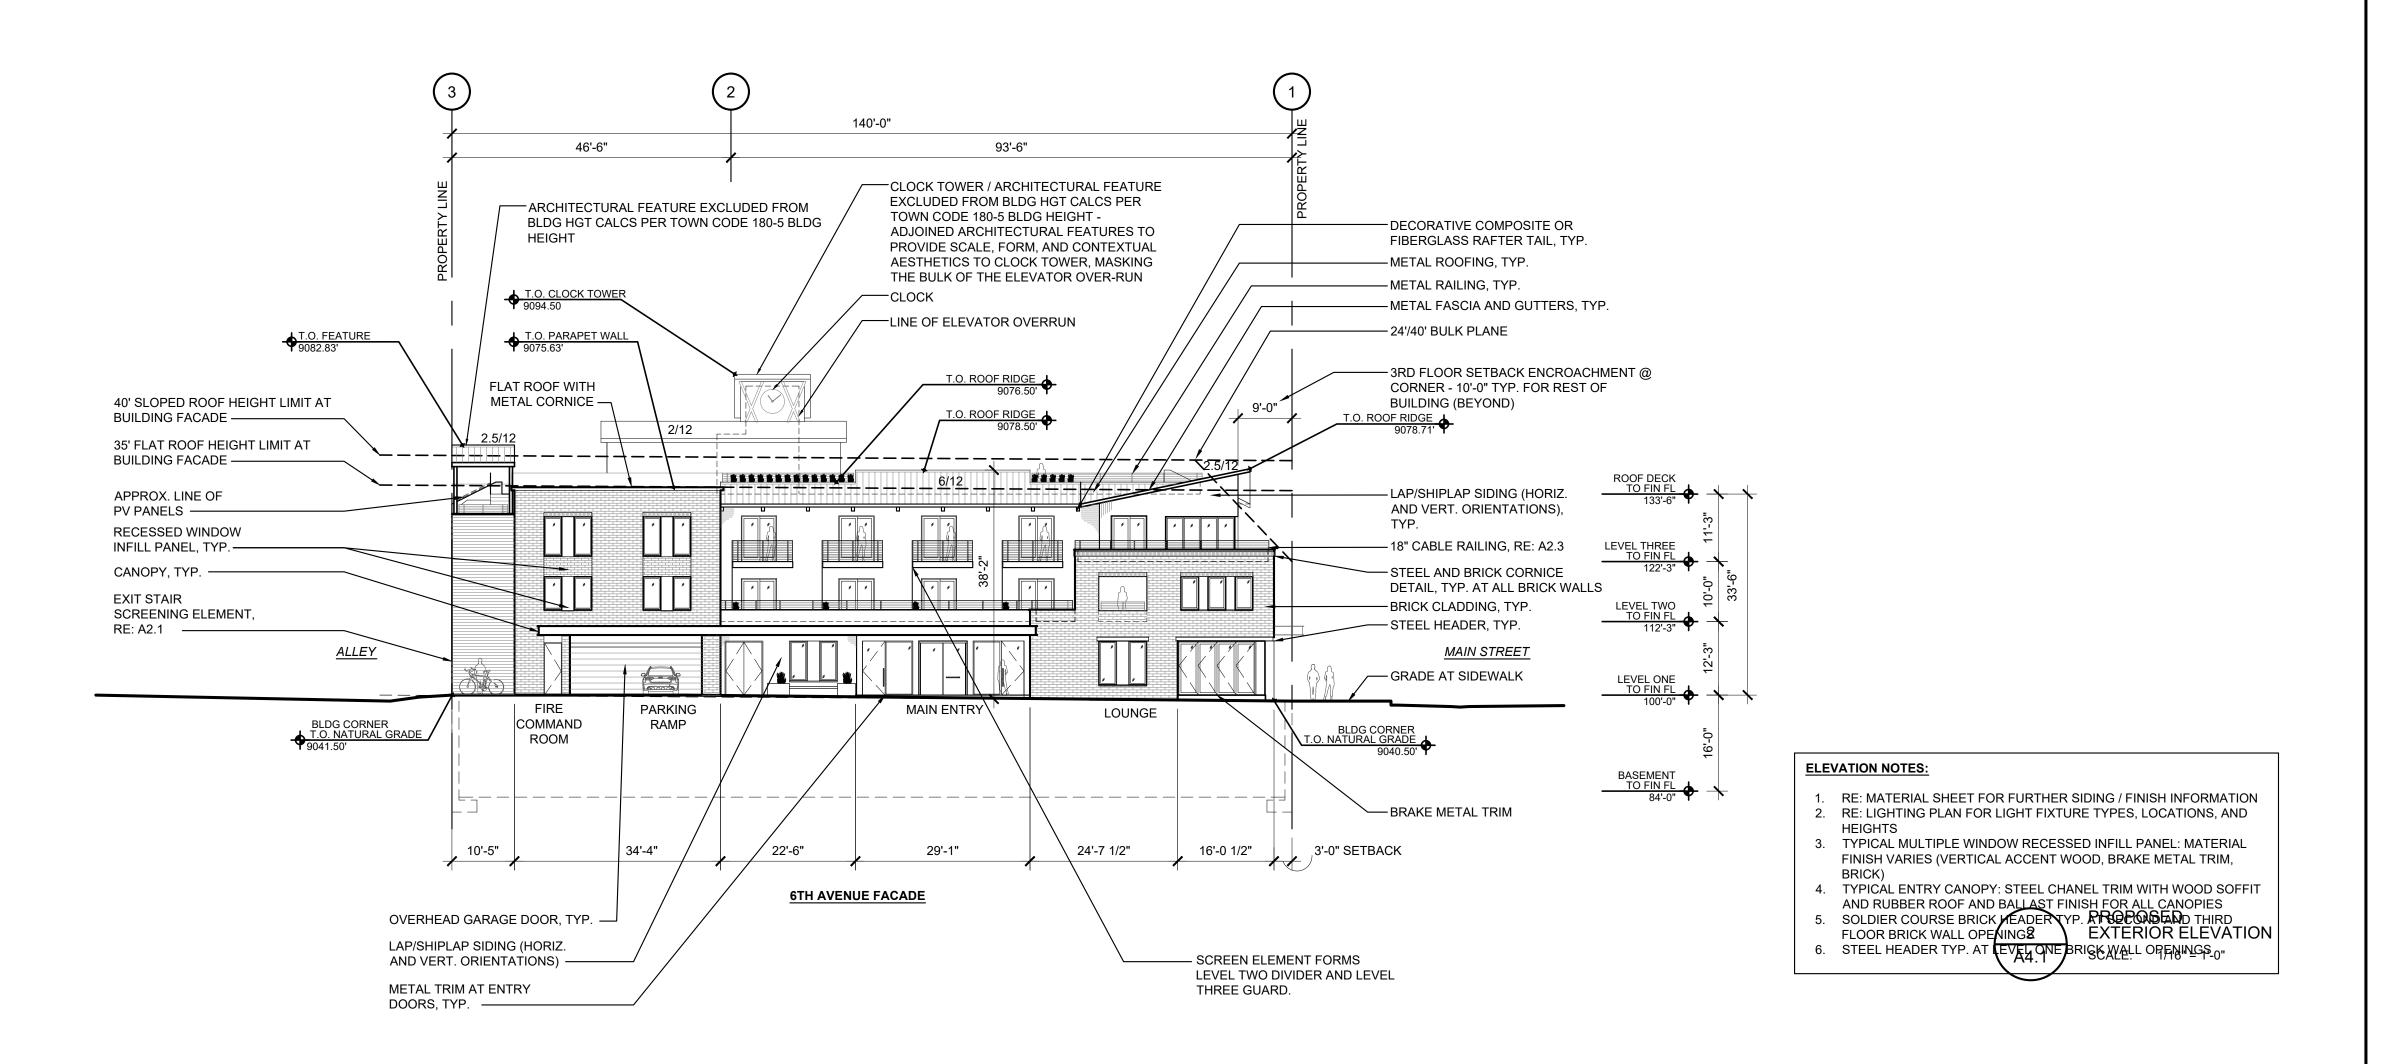

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Consultants

2017.05.15

SKETCH PLAN REVIEW & HISTORIC DISTRICT OVERLAY REZONE

2017.06.28

SKETCH PLAN REVIEW & HISTORIC DISTRICT OVERLAY REZONE - REVISION

2017.08.16

DEV. APPLICATION PRE-APP MTG

2017.09.06

DEV. APPLICATION & HISTORIC DISTRICT OVERLAY REZONE

2017.11.03

DEV. APPLICATION & HISTORIC

DISTRICT OVERLAY REZONE
- COMMENTS RESPONSE

FOOTES REST

BLOCK 11 500 MAIN STREET FRISCO, CO 80443

PROJECT NO: 21707 DWG FILE:


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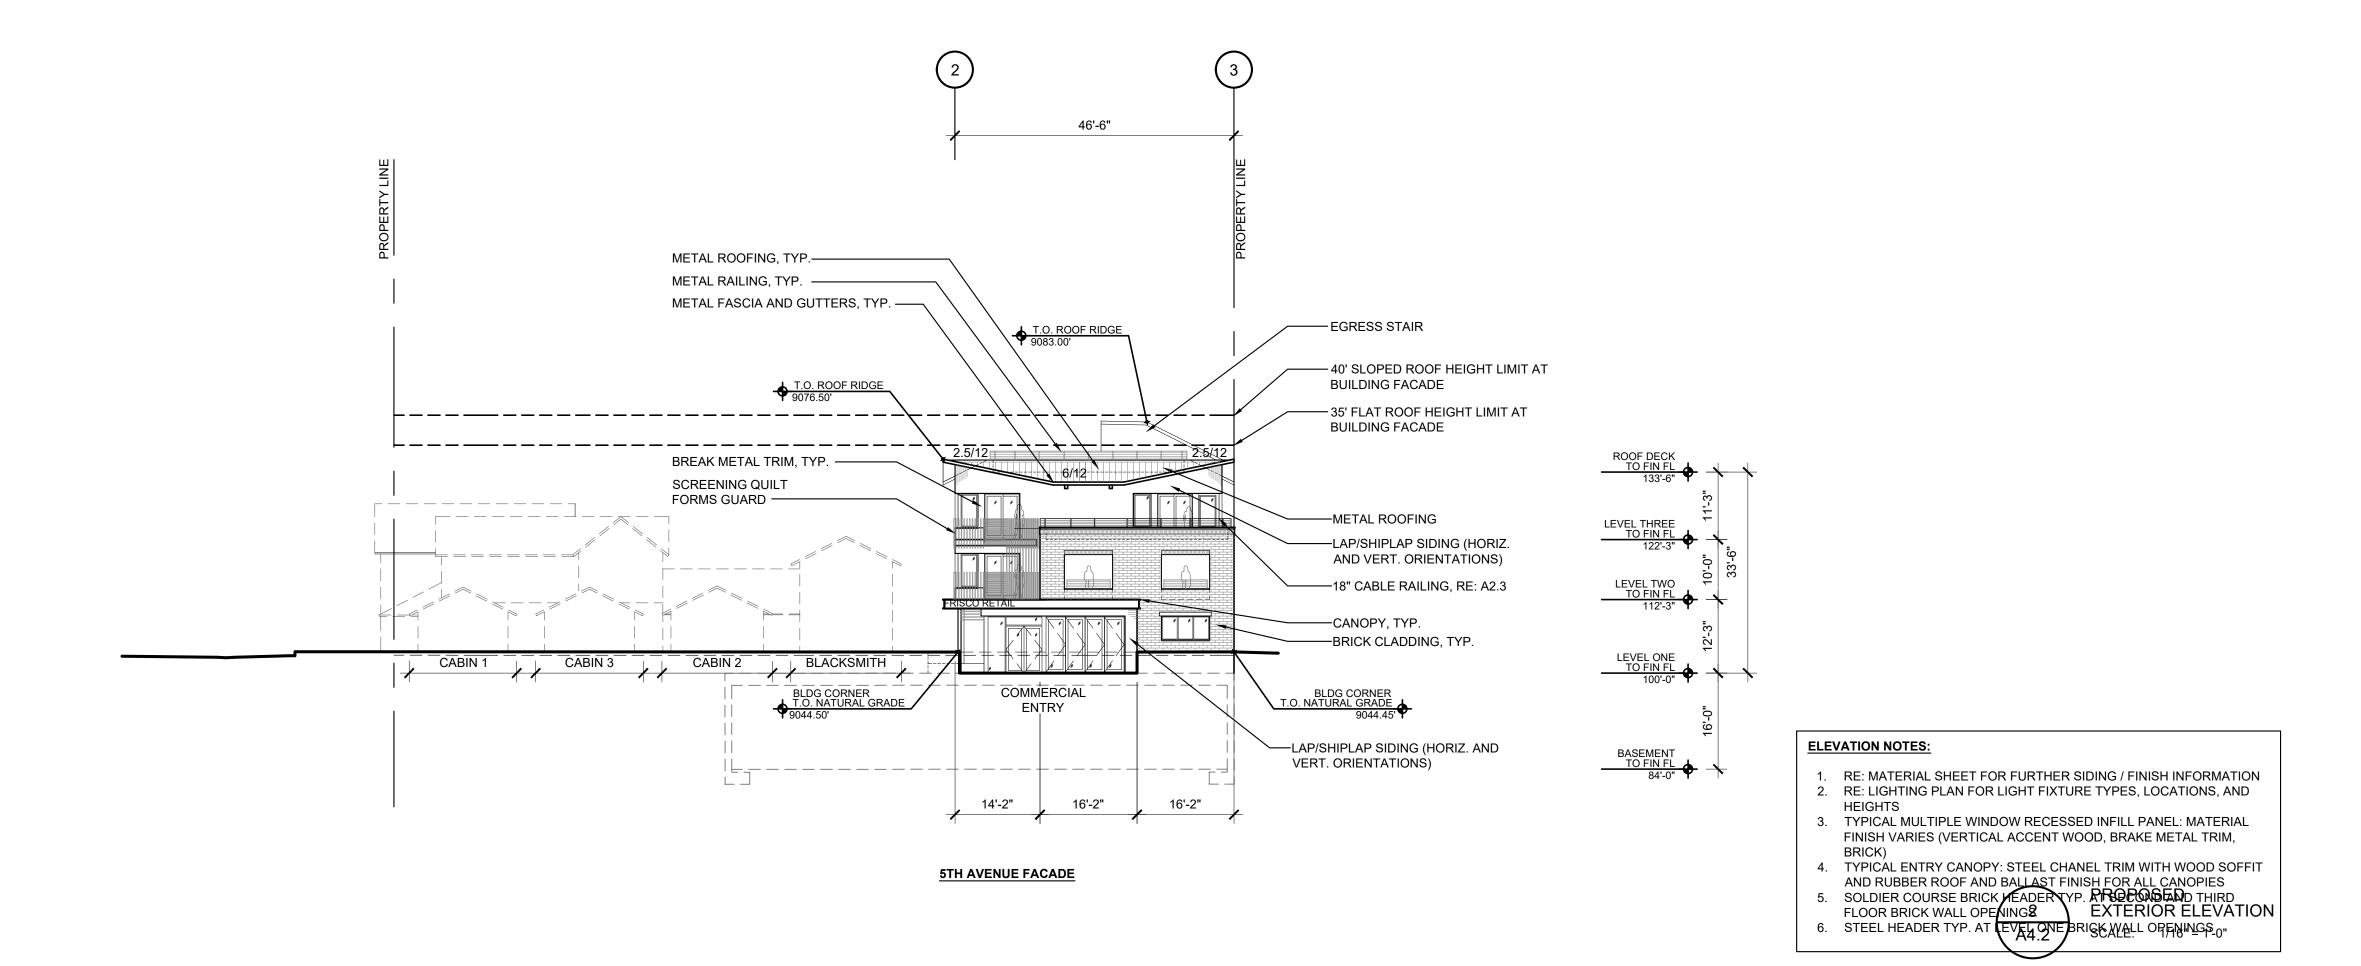
PROPOSED EXTERIOR

ELEVATIONS SCALE: 1/16"=1'-0"

A4 1

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2017.05.15 SKETCH PLAN REVIEW & HISTORIC DISTRICT OVERLAY REZONE 2017.06.28 SKETCH PLAN REVIEW & HISTORIC DISTRICT OVERLAY REZONE - REVISION 2017.08.16 DEV. APPLICATION PRE-APP MTG 2017.09.06 DEV. APPLICATION & HISTORIC DISTRICT OVERLAY REZONE 2017.11.03 DEV. APPLICATION & HISTORIC DISTRICT OVERLAY REZONE

- COMMENTS RESPONSE

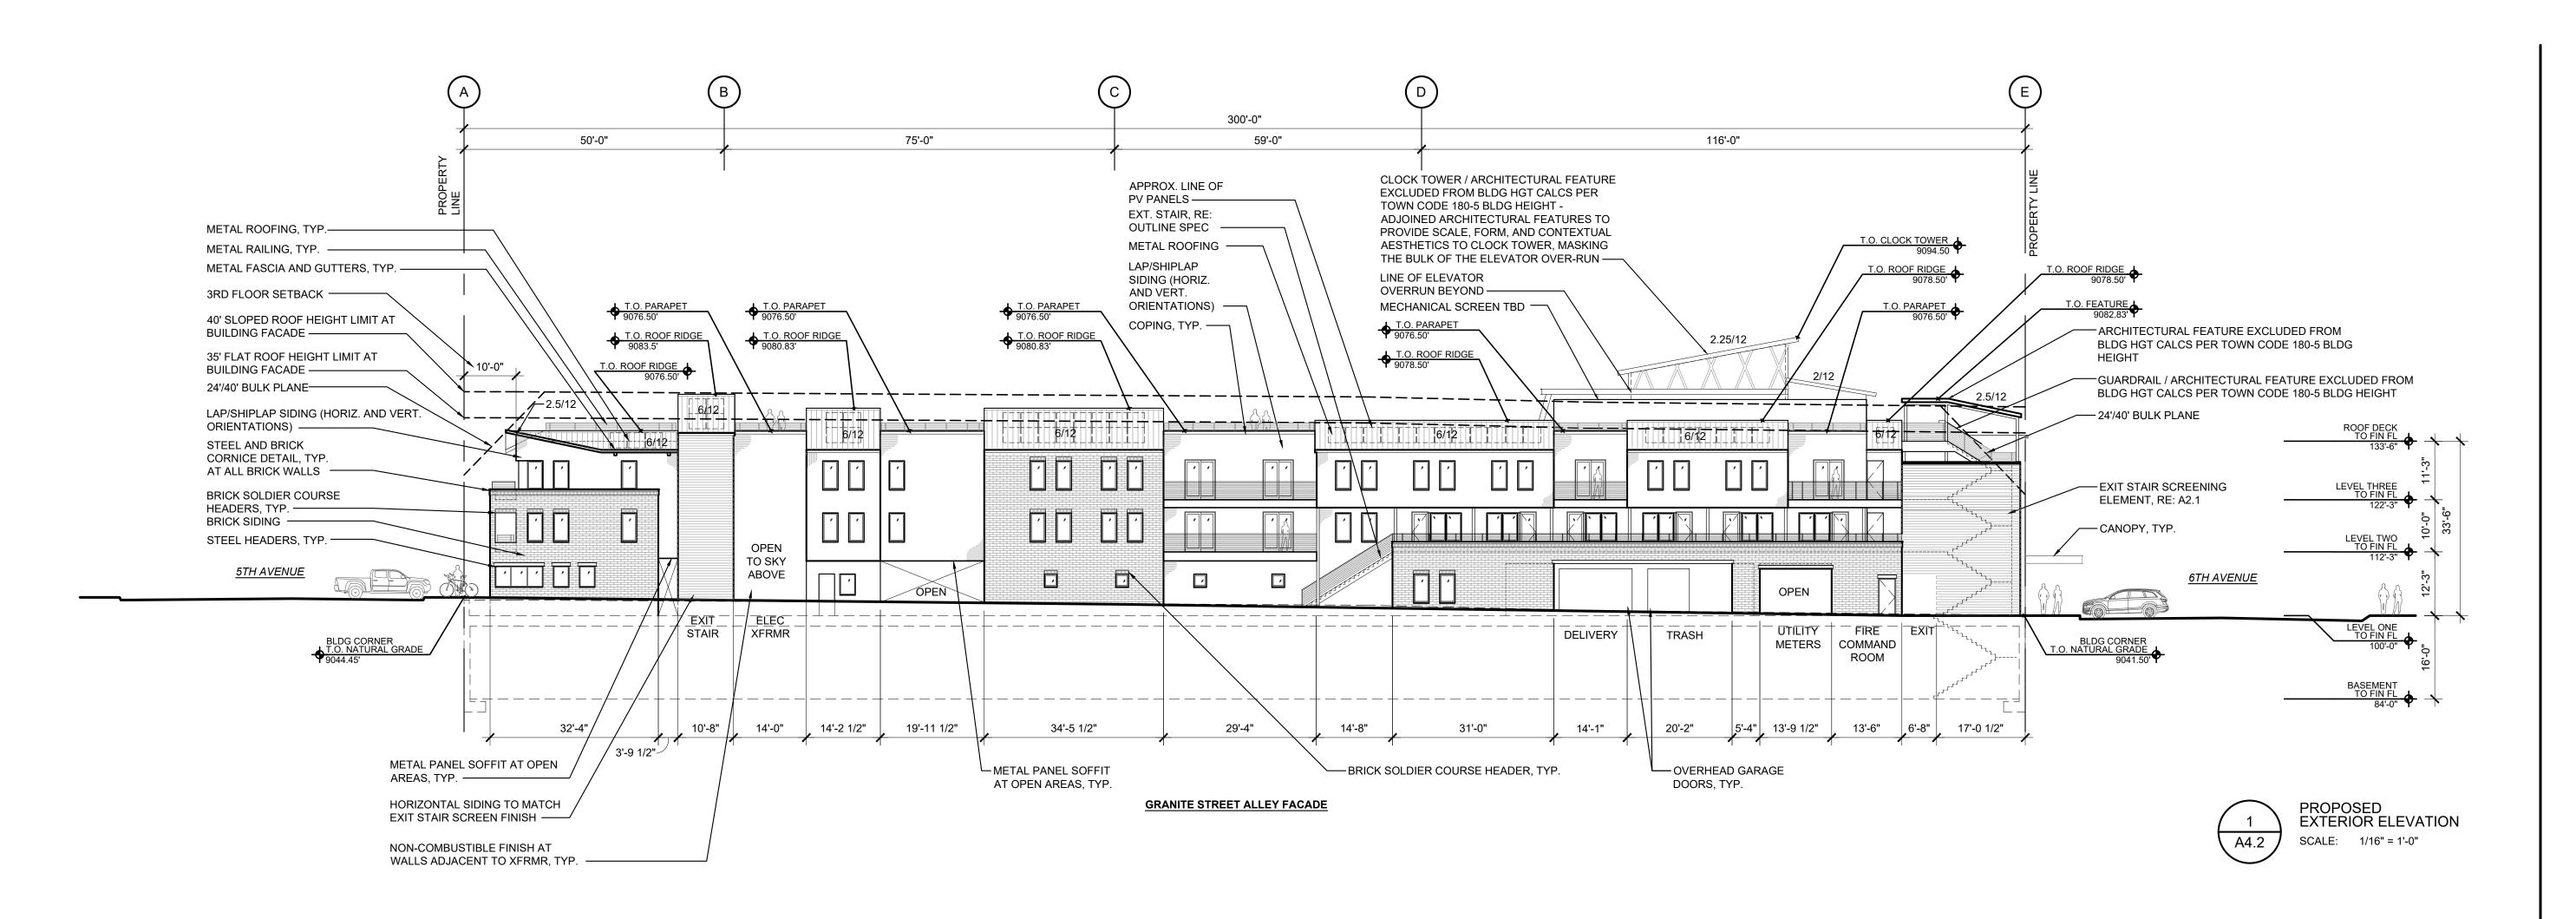FOOTES REST

BLOCK 11 500 MAIN STREET FRISCO, CO 80443

PROJECT NO: 21707 DWG FILE: 21707_A4-1.dwg


SHEET TITLE


PROPOSED EXTERIOR ELEVATIONS

SCALE: 1/16"=1'-0"


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303.308.1375 f

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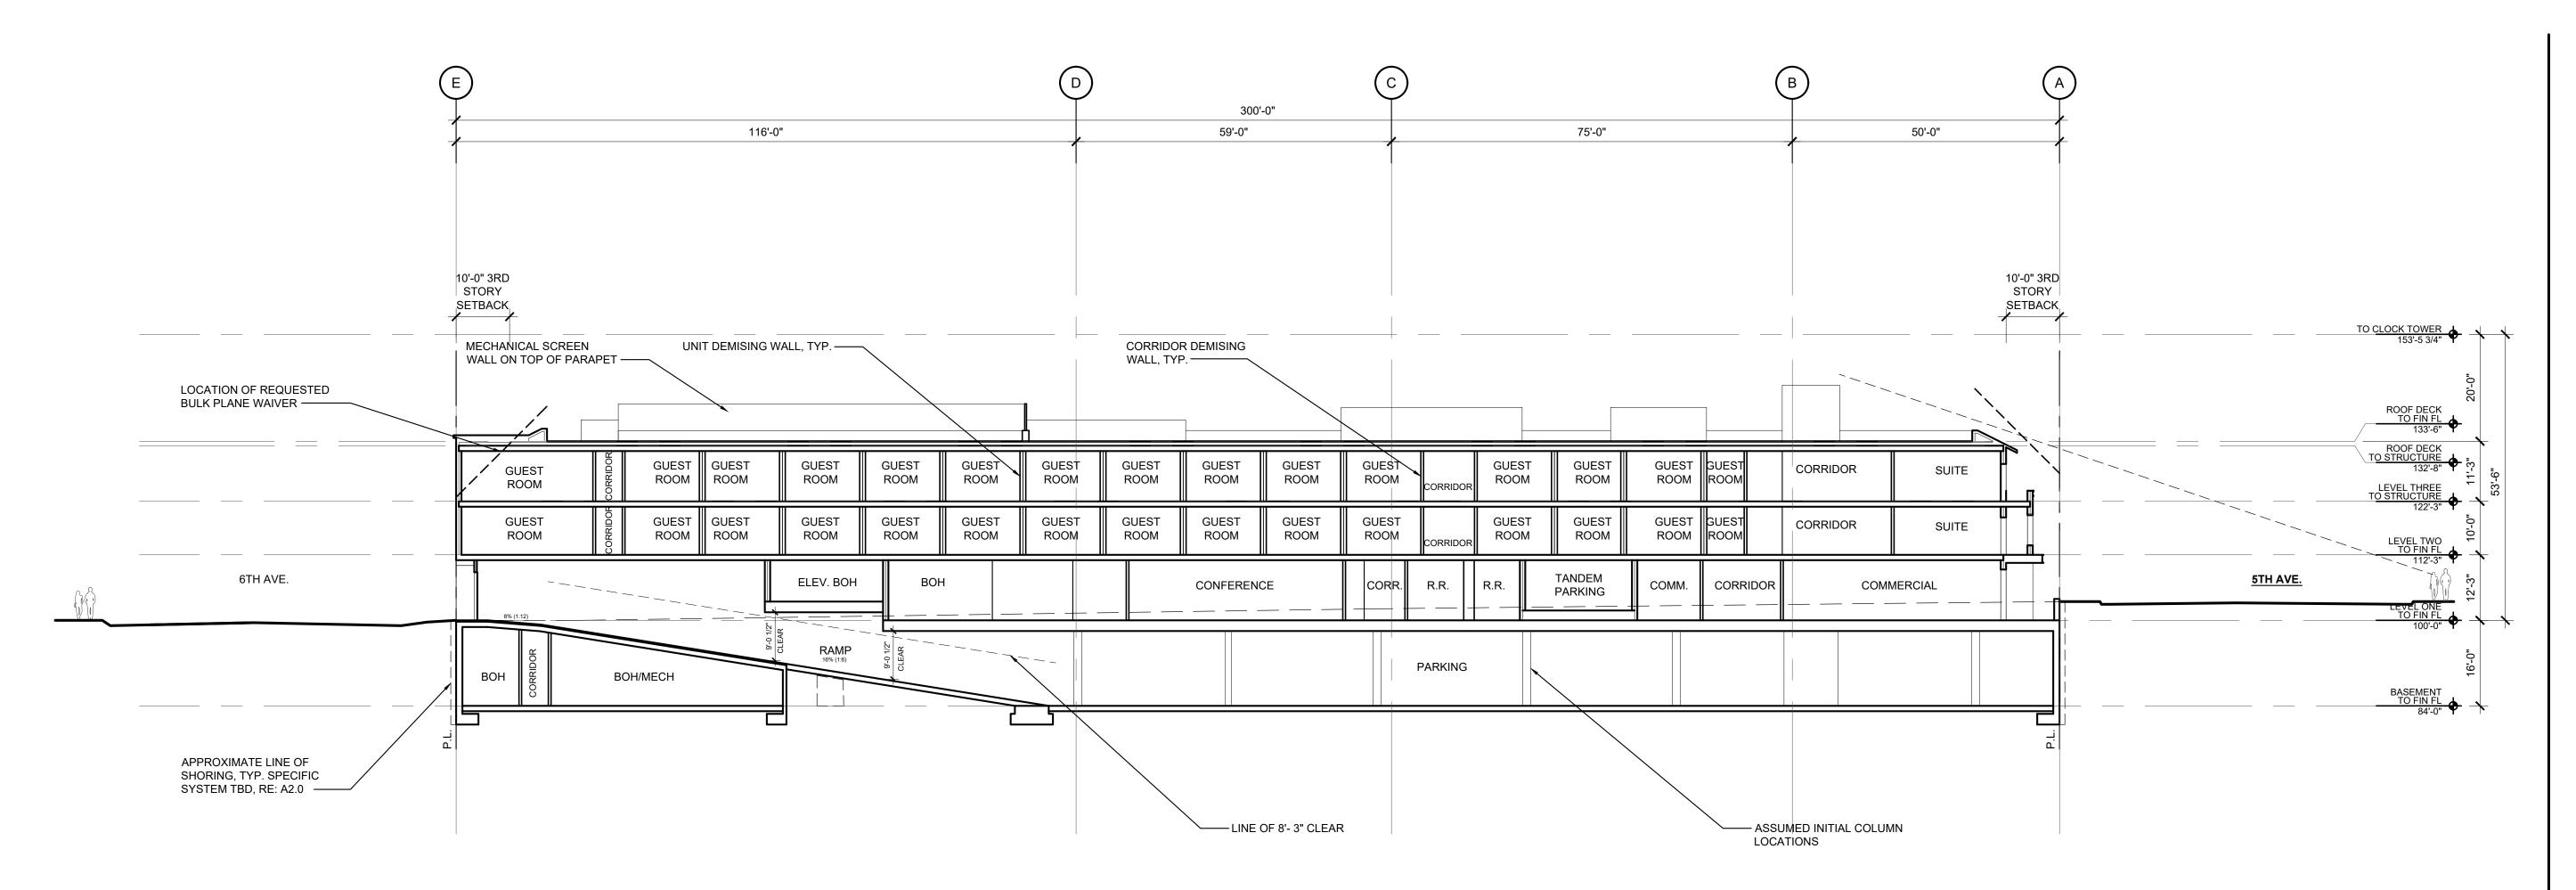
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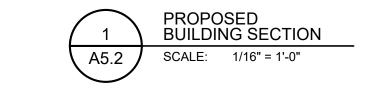
PROJECT NO: 21707 DWG FILE: 21707_A5-1.dwg

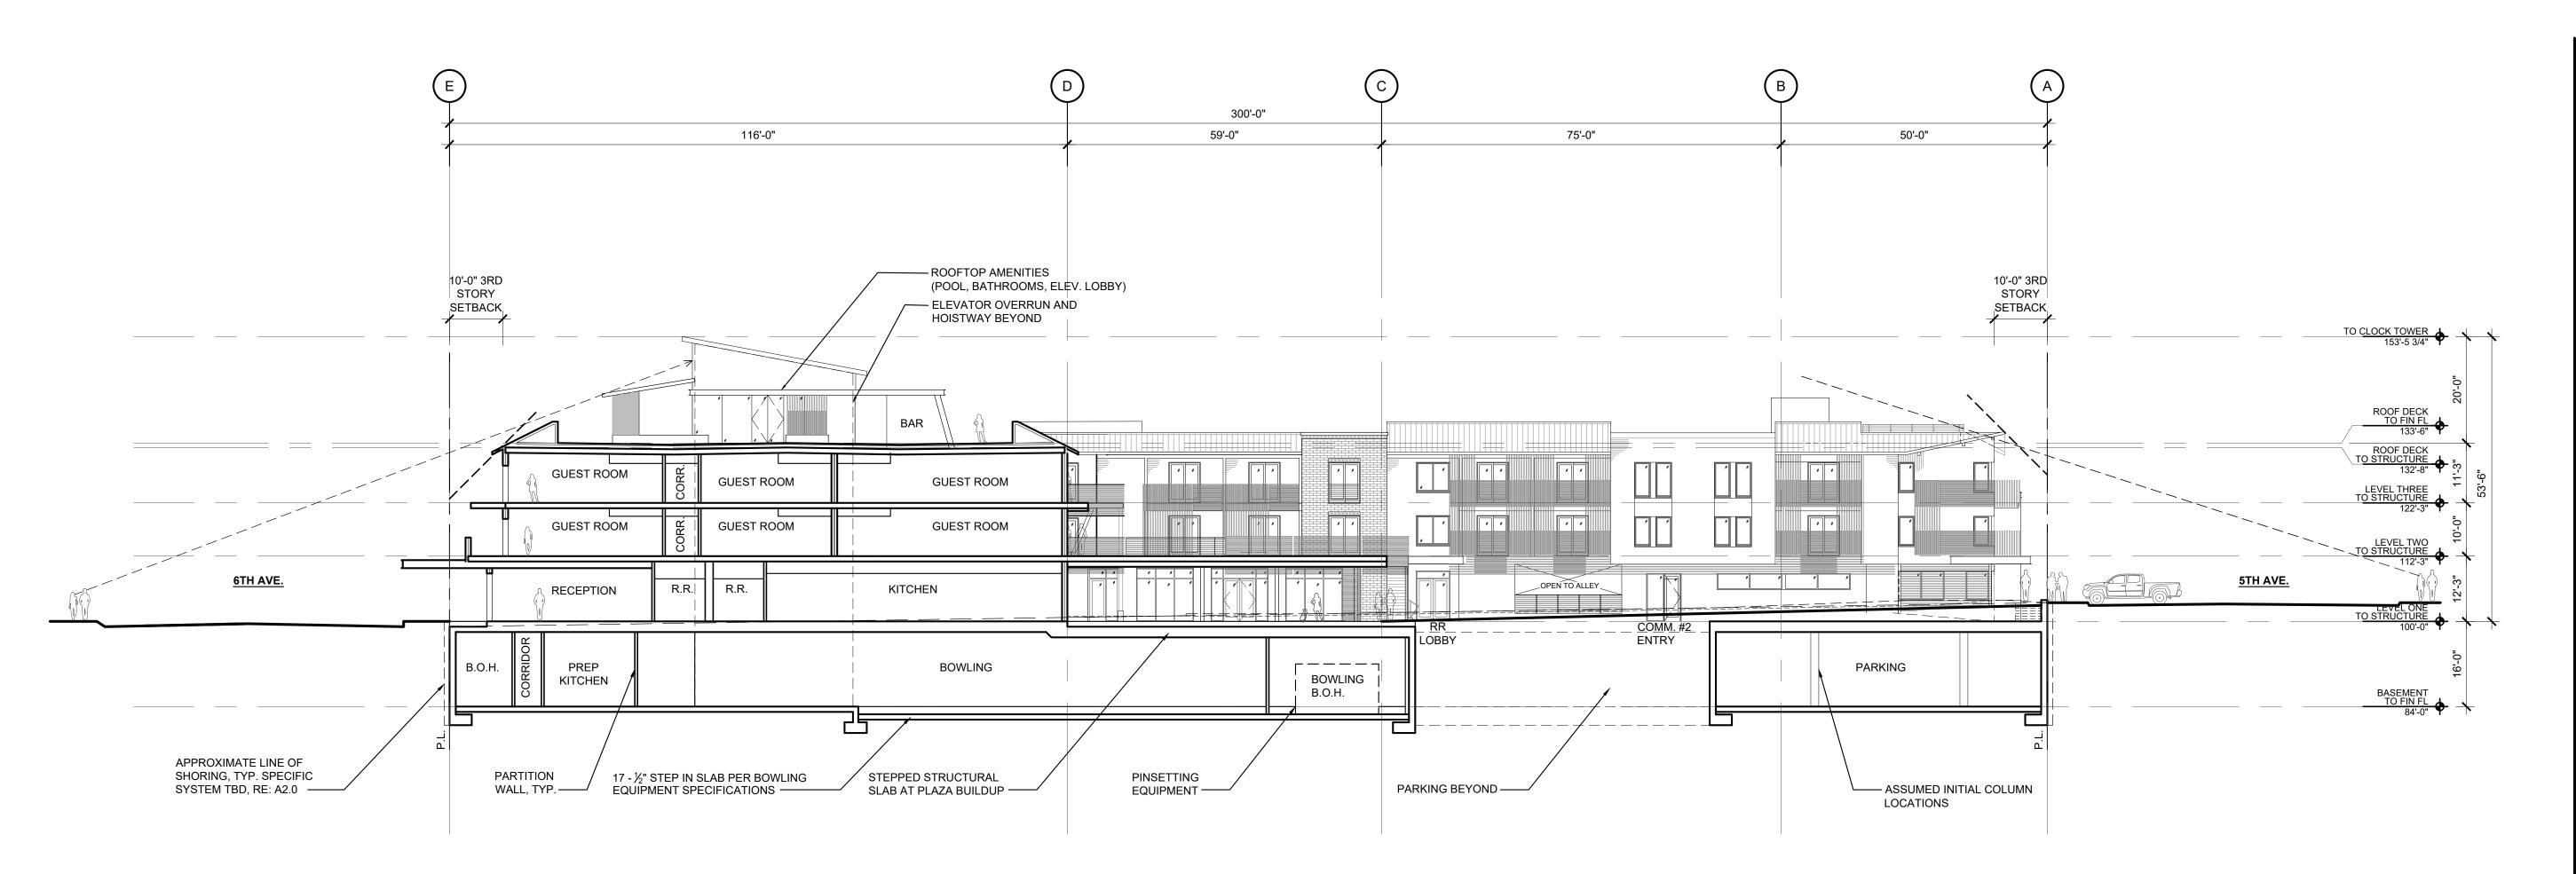SHEET TITLE

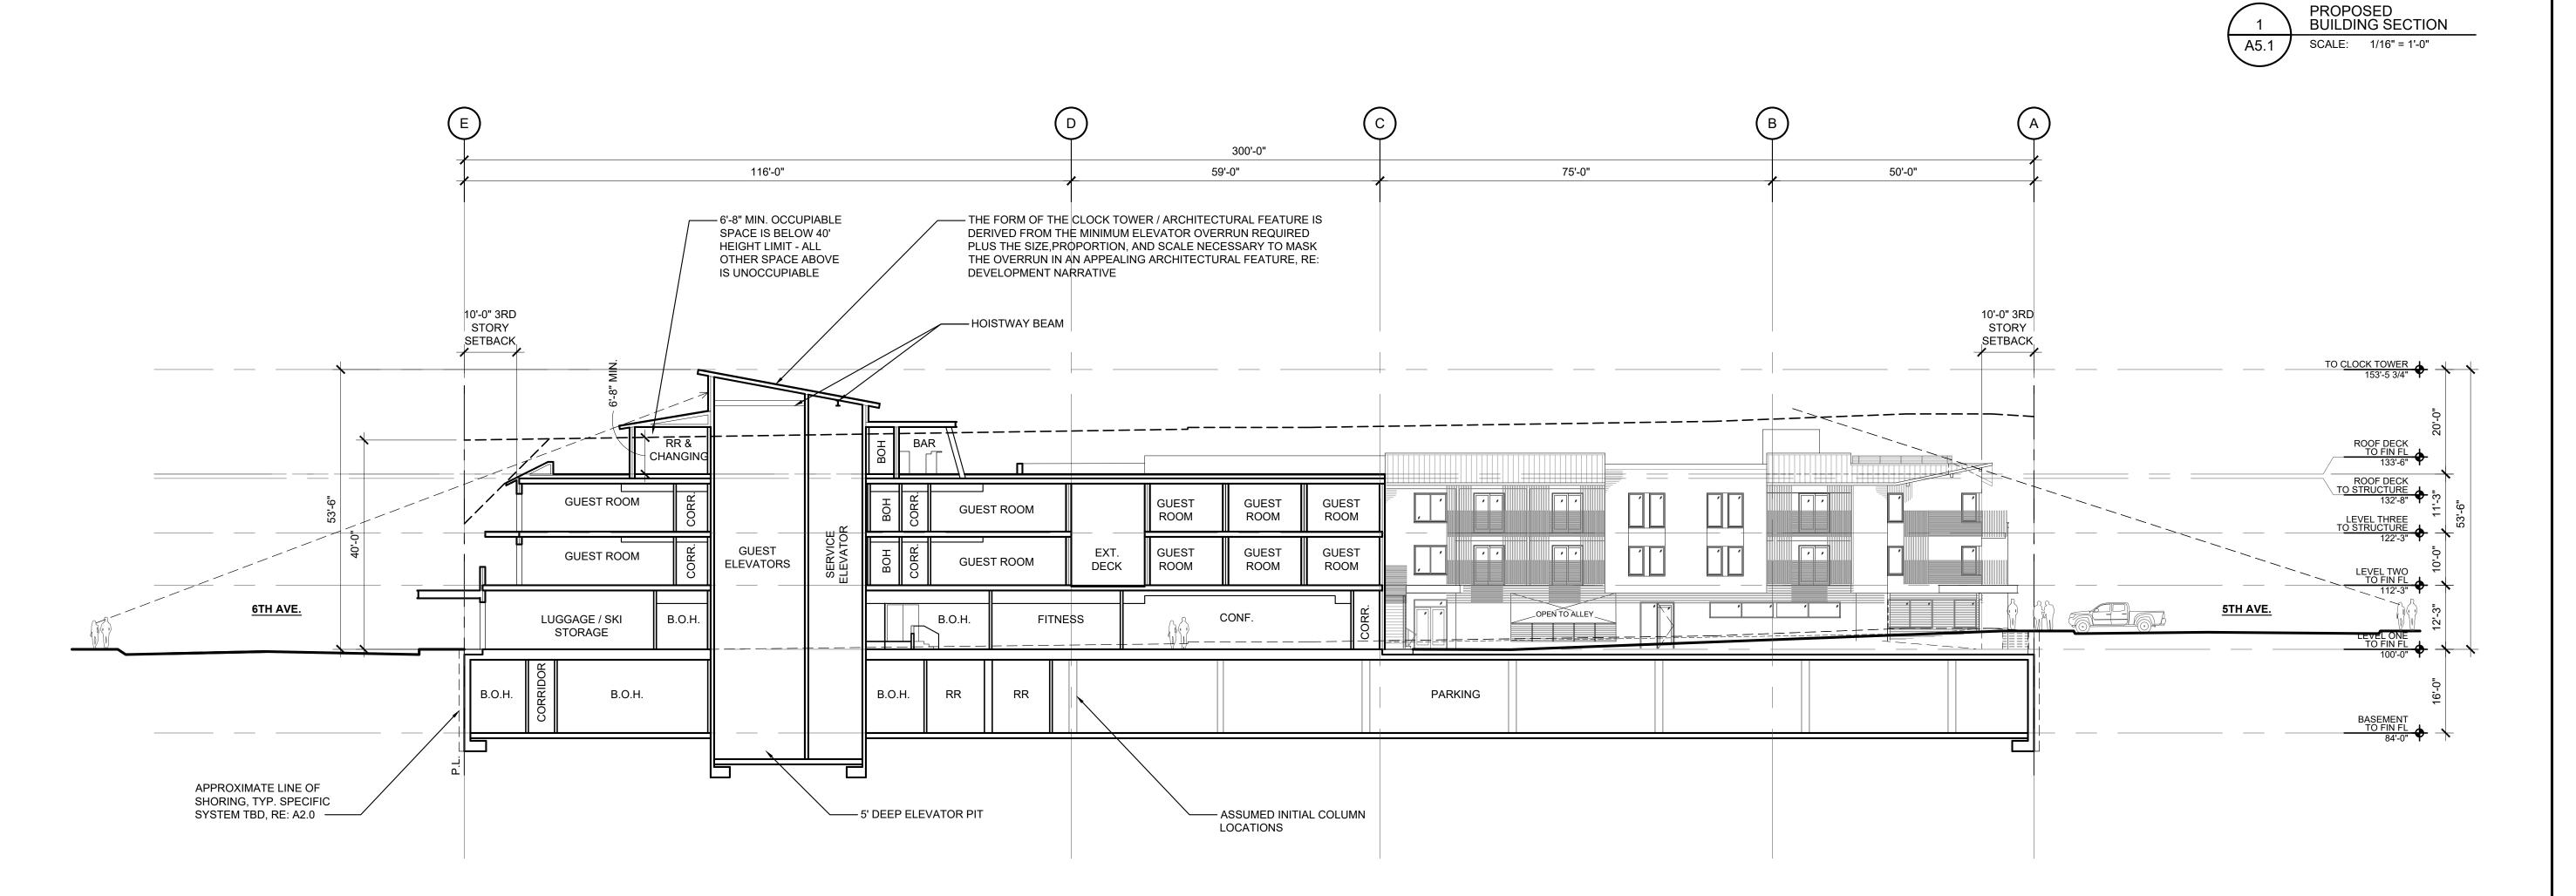PROPOSED
BUILDING
SECTIONS
SCALE: 1/16"=1'-0"

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FOOTES REST

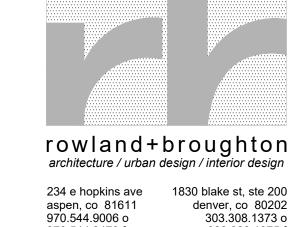BLOCK 11 500 MAIN STREET FRISCO, CO 80443


PROJECT NO: 21707 DWG FILE: 21707_A5-1.dwg

SHEET TITLE

PROPOSED BUILDING SECTIONS SCALE: 1/16"=1'-0"

A5 2

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SLOPE ARROW

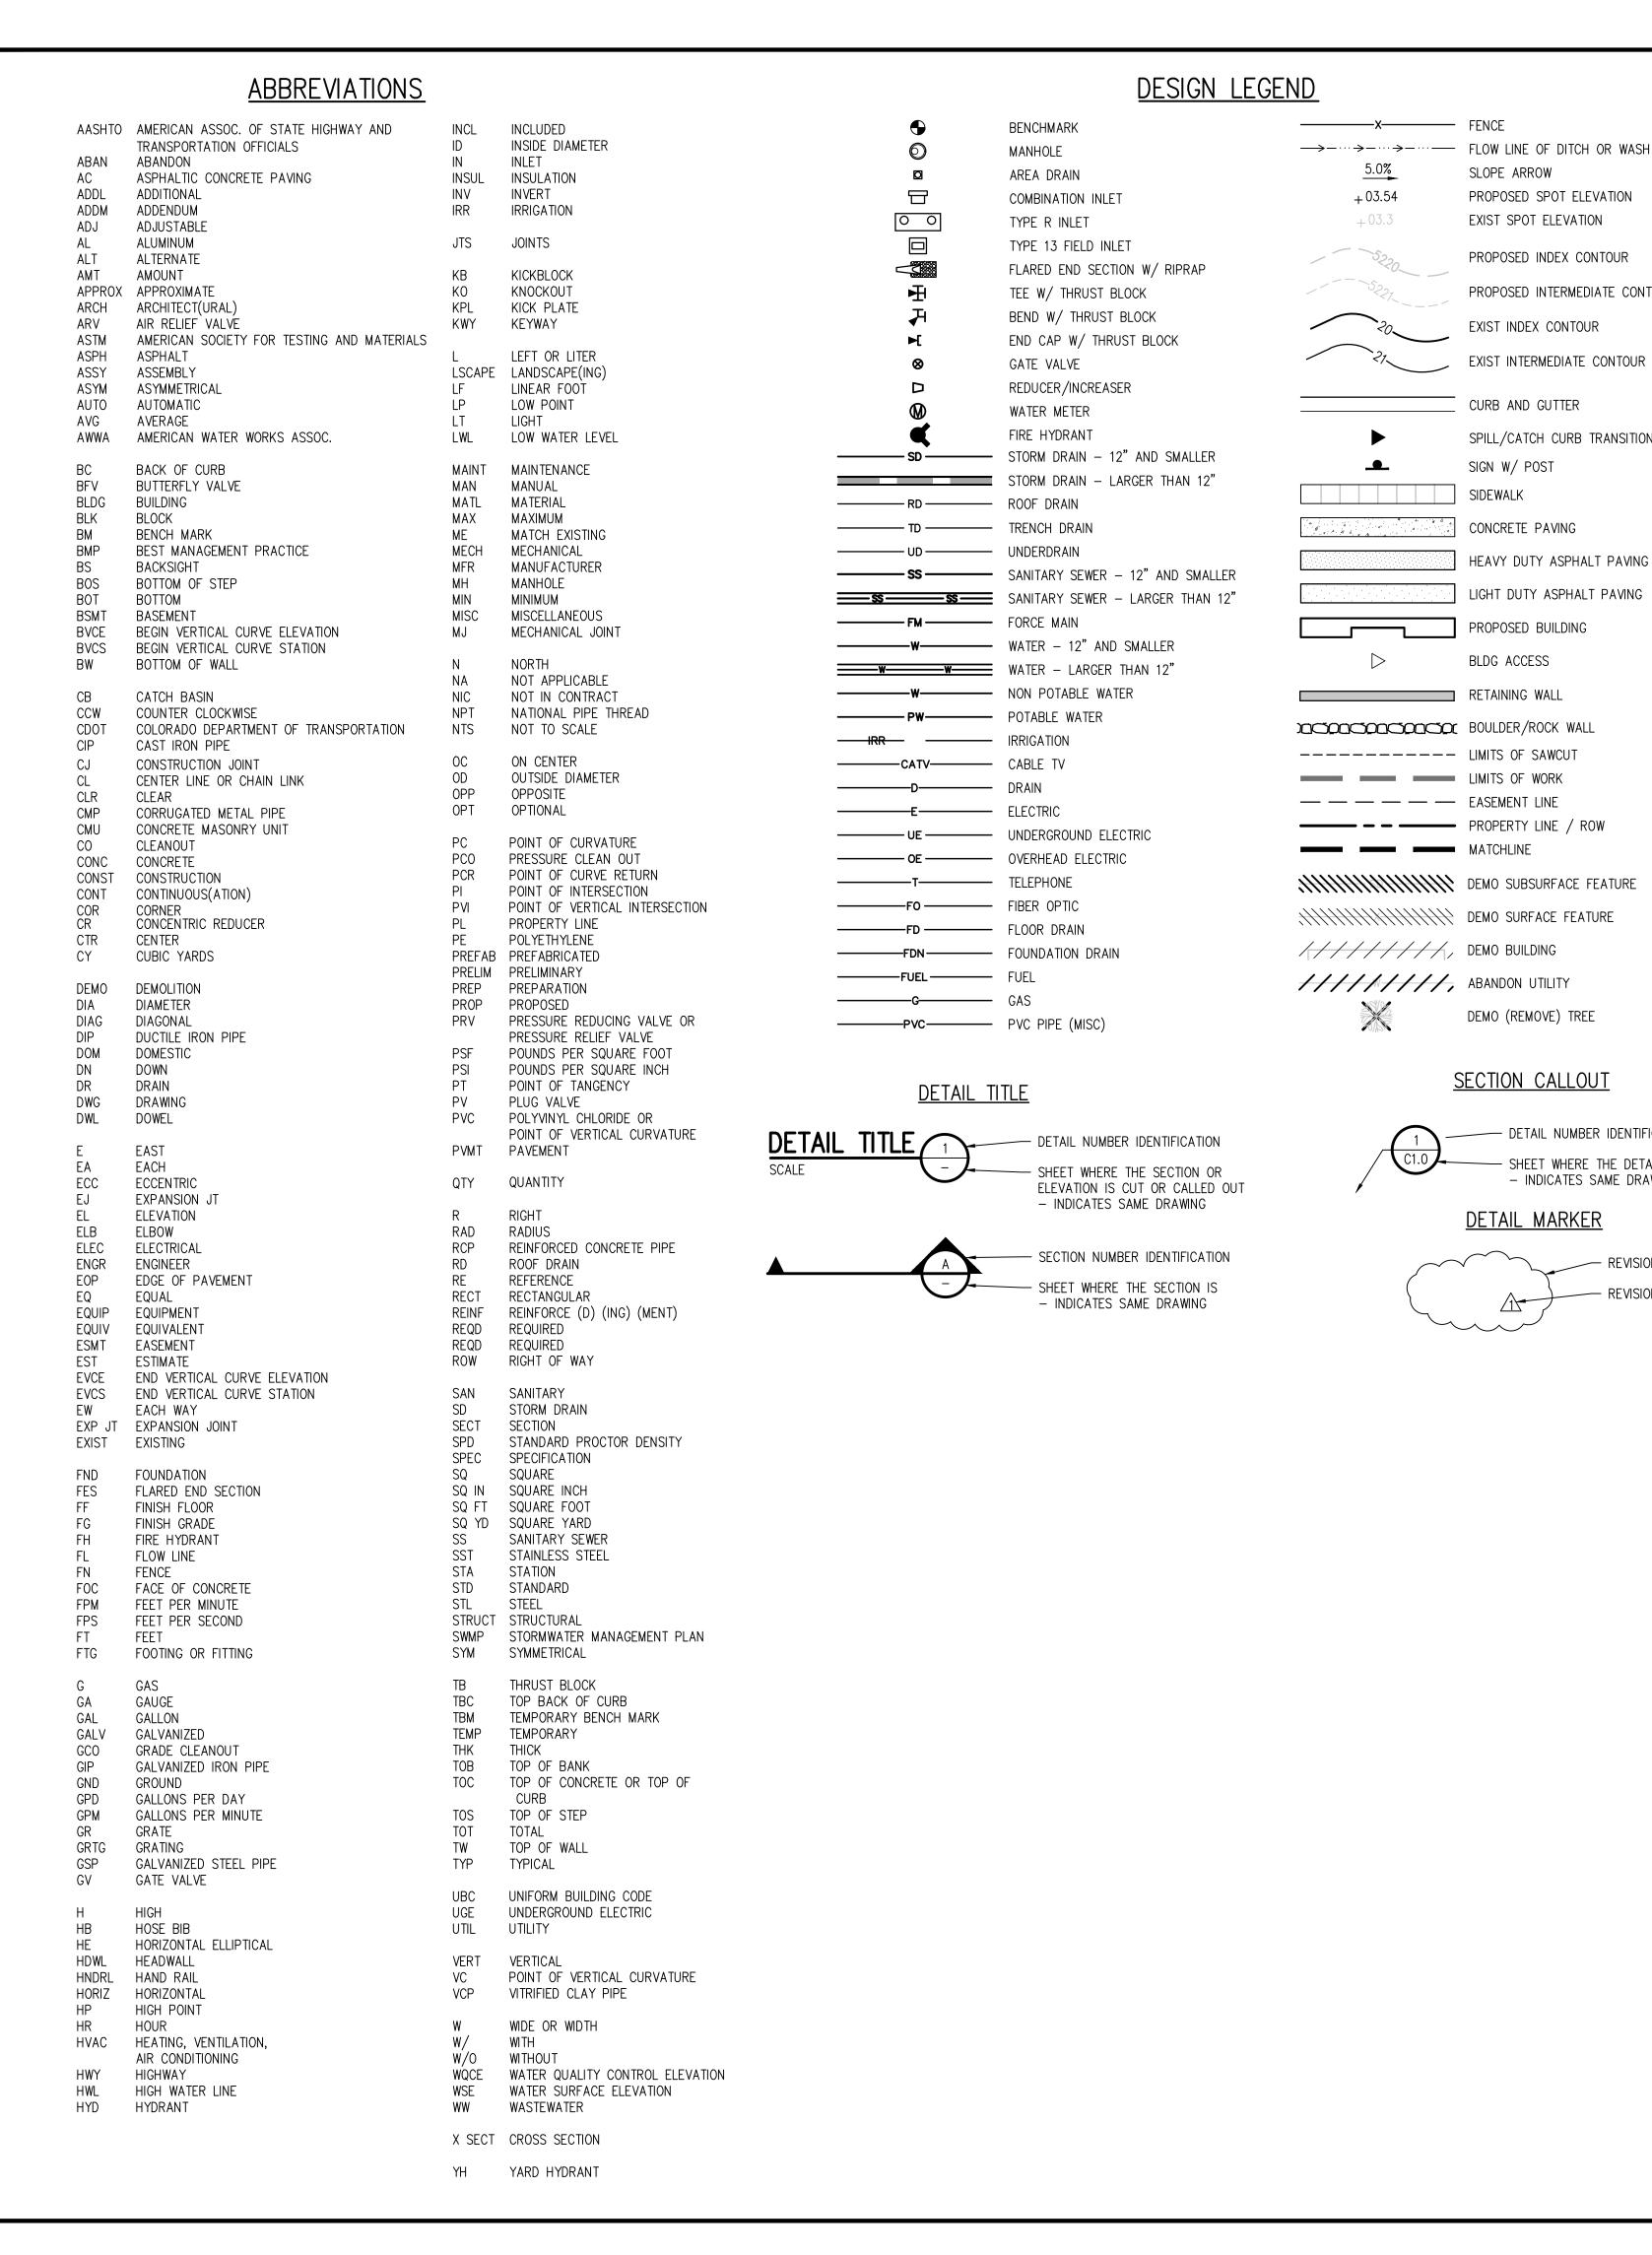PROPOSED SPOT ELEVATION

PROPOSED INDEX CONTOUR

PROPOSED INTERMEDIATE CONTOUR

EXIST INTERMEDIATE CONTOUR

SPILL/CATCH CURB TRANSITION

HEAVY DUTY ASPHALT PAVING

LIGHT DUTY ASPHALT PAVING

EXIST SPOT ELEVATION

EXIST INDEX CONTOUR

CURB AND GUTTER

SIGN W/ POST

CONCRETE PAVING

PROPOSED BUILDING

DEMO (REMOVE) TREE

SECTION C<u>ALLOUT</u>

DETAIL MARKER

— DETAIL NUMBER IDENTIFICATION

- SHEET WHERE THE DETAIL IS DRAWN

REVISION CLOUD

— REVISION NUMBER

BLDG ACCESS

SIDEWALK

ALL MATERIALS AND WORKMANSHIP SHALL BE IN CONFORMANCE WITH THE LATEST STANDARDS AND SPECIFICATIONS OF THE TOWN OF FRISCO, LAKE DILLON FIRE PROTECTION DISTRICT REQUIREMENTS, AND APPLICABLE STATE AND LOCAL STANDARDS AND SPECIFICATIONS. THE CONTRACTOR SHALL HAVE IN POSSESSION AT THE JOB SITE AT ALL TIMES ONE (1) SIGNED COPY OF APPROVED PLANS, APPLICABLE STANDARDS, AND SPECIFICATIONS. CONTRACTOR SHALL CONSTRUCT AND MAINTAIN EMERGENCY ACCESS ROUTES TO THE SITE AND STRUCTURE AT ALL TIMES PER THE APPLICABLE LAKE DILLON FIRE PROTECTION DISTRICT REQUIREMENTS. THE CONTRACTOR SHALL OBTAIN WRITTEN APPROVAL FOR ANY VARIANCE TO THE ABOVE DOCUMENTS, NOTIFY ENGINEER OF ANY CONFLICTING STANDARDS OR SPECIFICATIONS. IN THE EVENT OF ANY CONFLICTING STANDARD OR SPECIFICATION, THE MORE STRINGENT OR HIGHER QUALITY STANDARD, DETAIL, OR SPECIFICATION SHALL APPLY.

THE CONTRACTOR SHALL OBTAIN, AT HIS OWN EXPENSE, ALL APPLICABLE CODES, LICENSES, STANDARD SPECIFICATIONS, PERMITS, BONDS, ETC. WHICH ARE NECESSARY TO PERFORM THE PROPOSED WORK, INCLUDING BUT NOT LIMITED TO A LOCAL AND STATE GROUNDWATER DISCHARGE AND COLORADO DEPARTMENT OF HEALTH AND ENVIRONMENT (CDPHE) STORMWATER DISCHARGE PERMIT ASSOCIATED WITH CONSTRUCTION ACTIVITY.

3. THE CONTRACTOR SHALL BE RESPONSIBLE FOR NOTIFYING THE REQUIRED PARTY (OWNER, OWNER'S REPRESENTATIVE, MUNICIPAL/DISTRICT INSPECTOR, GEOTECHNICAL ENGINEER, ENGINEER, AND/OR UTILITY OWNER) AT LEAST 48 HOURS PRIOR TO START OF ANY CONSTRUCTION, PRIOR TO BACKFILLING, AND AS REQUIRED BY JURISDICTIONAL AUTHORITY AND/OR PROJECT SPECIFICATIONS. THE CONTRACTOR SHALL CONTINUE WITH NOTIFICATIONS THROUGHOUT THE PROJECT AS REQUIRED BY THE STANDARDS AND SPECIFICATIONS. THE LOCATIONS OF EXISTING UTILITIES ARE SHOWN IN THE APPROXIMATE LOCATION BASED ON INFORMATION BY OTHERS. NOT ALL UTILITIES MAY BE SHOWN. THE CONTRACTOR SHALL DETERMINE THE EXACT LOCATION OF ALL

EXISTING UTILITIES WHETHER SHOWN OR NOT BEFORE COMMENCING WORK. THE CONTRACTOR SHALL BE FULLY AND SOLELY RESPONSIBLE FOR ANY AND ALL DAMAGES AND COSTS WHICH MIGHT OCCUR BY THE CONTRACTOR'S FAILURE TO EXACTLY LOCATE AND PRESERVE ANY AND ALL UTILITIES. THE CONTRACTOR SHALL NOTIFY ALL PUBLIC AND PRIVATE UTILITY COMPANIES AND DETERMINE THE LOCATION OF ALL EXISTING UTILITIES PRIOR TO PROCEEDING WITH GRADING AND CONSTRUCTION. ALL WORK PERFORMED IN THE AREA OF UTILITIES SHALL BE PERFORMED AND INSPECTED ACCORDING TO THE REQUIREMENTS OF THE UTILITY OWNER. LIKEWISE, THE CONTRACTOR SHALL BE RESPONSIBLE FOR LOCATING AND MAPPING ANY EXISTING UTILITY (INCLUDING DEPTH) WHICH MAY CONFLICT WITH THE PROPOSED CONSTRUCTION. AND FOR RELOCATING ENCOUNTERED UTILITIES AS DIRECTED BY THE ENGINEER. CONTRACTOR SHALL CONTACT AND RECEIVE APPROVAL FROM TOWN OF FRISCO UTILITY OWNER, AND ENGINEER BEFORE RELOCATING ANY ENCOUNTERED UTILITIES. CONTRACTOR RESPONSIBLE FOR SERVICE CONNECTIONS. AND RELOCATING AND RECONNECTING AFFECTED UTILITIES AS COORDINATED WITH UTILITY OWNER AND/OR ENGINEER, INCLUDING NON-MUNICIPAL UTILITIES (TELEPHONE, GAS, CABLE, ETC., WHICH SHALL BE COORDINATED WITH THE UTILITY OWNER). THE CONTRACTOR SHALL IMMEDIATELY CONTACT ENGINEER UPON DISCOVERY OF A UTILITY DISCREPANCY OR CONFLICT. AT LEAST 48 HOURS PRIOR TO CONSTRUCTION, THE

CONTRACTOR SHALL NOTIFY THE UTILITY NOTIFICATION CENTER OF COLORADO (1-800-922-1987, WWW.UNCC.ORG) THE CONTRACTOR SHALL BE SOLELY AND COMPLETELY RESPONSIBLE FOR CONDITIONS AT AND ADJACENT TO THE JOB SITE, INCLUDING SAFETY OF ALL PERSONS AND PROPERTY DURING THE PERFORMANCE OF THE WORK. THE CONTRACTOR SHALL PREPARE A TRAFFIC CONTROL PLAN FOR OWNER APPROVAL AND PROVIDE ALL LIGHTS, SIGNS, BARRICADES, FENCING, FLAGMAN OR OTHER DEVICES NECESSARY TO PROVIDE FOR PUBLIC SAFETY. THIS REQUIREMENT SHALL APPLY CONTINUOUSLY AND NOT BE LIMITED TO NORMAL WORKING HOURS. THE CONTRACTOR AGREES TO COMPLY WITH THE PROVISIONS OF THE TRAFFIC CONTROL PLAN AND THE LATEST EDITION OF THE "MANUAL ON UNIFORM TRAFFIC CONTROL DEVICES," PART VI, FOR CONSTRUCTION SIGNAGE AND TRAFFIC CONTROL ALL TEMPORARY AND PERMANENT TRAFFIC SIGNS SHALL COMPLY TO THE MANUAL ON UNIFORM TRAFFIC CONTROL DEVICES (MUTCD) WITH REGARD TO SIGN SHAPE, COLOR, SIZE, LETTERING, ETC. UNLESS OTHERWISE SPECIFIED. IF APPLICABLE, PART NUMBERS ON SIGNAGE DETAILS REFER TO MUTCD SIGN NUMBERS.

THE CONTRACTOR SHALL BE RESPONSIBLE FOR REMOVING ANY GROUNDWATER ENCOUNTERED DURING THE CONSTRUCTION OF ANY PORTION OF THIS PROJECT. GROUNDWATER SHALL BE PUMPED, PIPED, REMOVED AND DISPOSED OF IN A MANNER WHICH DOES NOT CAUSE FLOODING OF EXISTING STREETS NOR EROSION ON ABUTTING PROPERTIES IN ORDER TO CONSTRUCT THE IMPROVEMENTS SHOWN ON THESE PLANS.

7. RIM AND GRATE ELEVATIONS SHOWN ON PLANS ARE APPROXIMATE ONLY AND ARE NOT TO BE TAKEN AS FINAL ELEVATIONS. THE CONTRACTOR SHALL ADJUST RIMS AND OTHER IMPROVEMENTS TO MATCH FINAL PAVEMENT AND FINISHED GRADE ELEVATIONS.

8. THE EXISTING AND PROPOSED ELEVATIONS OF FLATWORK, SIDEWALKS, CURBS, PAVING, ETC. AS SHOWN HEREON ARE BASED ON EXTRAPOLATION OF FIELD SURVEY DATA AND EXISTING CONDITIONS. AT CRITICAL AREAS AND SITE FEATURES, CONTRACTOR SHALL HAVE FORMWORK INSPECTED AND APPROVED BY OWNER PRIOR TO PLACING CONCRETE. MINOR ADJUSTMENTS, AS APPROVED BY OWNER, TO PROPOSED GRADES, INVERTS, ETC. MAY BE REQUIRED TO PREVENT PONDING. ALL FLATWORK MUST PREVENT PONDING AND PROVIDE POSITIVE DRAINAGE AWAY FROM EXISTING AND PROPOSED BUILDINGS, WALLS, ROOF DRAIN OUTFALLS, ACROSS DRIVES AND WALKS, ETC., TOWARDS THE PROPOSED INTENDED DRAINAGE FEATURES AND CONVEYANCES.

FINAL LIMITS OF REQUIRED ASPHALT SAWCUTTING AND PATCHING MAY VARY FROM LIMITS SHOWN ON PLANS. CONTRACTOR TO PROVIDE SAWCUT AND PATCH WORK TO ACHIEVE POSITIVE DRAINAGE AND A SMOOTH TRANSITION TO EXISTING ASPHALT WITHIN ACCEPTABLE DRIVE SLOPE STANDARDS PER ENGINEER. CONTRACTOR SHALL PROVIDE ADDITIONAL SAWCUTTING AND PATCHING AT UTILITY WORK, ETC. THAT MAY NOT BE DELINEATED ON PLANS.

10. ANY EXISTING MONITORING WELLS, CLEANOUTS, VALVE BOXES, ETC. TO BE PROTECTED AND TO REMAIN IN SERVICE IF FEATURES EXIST, EXTEND OR LOWER TO FINAL SURFACE WITH LIKE KIND CAP WITH STANDARD CAST ACCESS LID WITH SAME MARKINGS. IN LANDSCAPED AREAS PROVIDE A CONCRETE COLLAR (18"x18"x6" THICK) AT ALL EXISTING AND PROPOSED MONITORING WELLS, CLEANOUTS, VALVE BOXES, ETC.

11. OWNER TO APPROVE ALL CONCRETE FINISHING, JOINT PATTERNS AND COLORING REQUIREMENTS PRIOR TO

CONSTRUCTION. SUBMIT JOINT LAYOUT PLAN TO OWNER FOR APPROVAL PRIOR TO CONSTRUCTION. 12. PIPE LENGTHS AND HORIZONTAL CONTROL POINTS SHOWN ARE FROM CENTER OF STRUCTURES, END OF FLARED END SECTIONS, ETC. SEE STRUCTURE DETAILS FOR EXACT HORIZONTAL CONTROL LOCATION. CONTRACTOR IS RESPONSIBLE FOR ADJUSTING ACTUAL PIPE LENGTHS TO ACCOUNT FOR STRUCTURES AND LENGTH OF FLARED END

13. ALL SURPLUS MATERIALS, TOOLS, AND TEMPORARY STRUCTURES, FURNISHED BY THE CONTRACTOR, SHALL BE REMOVED FROM THE PROJECT SITE BY THE CONTRACTOR. ALL DEBRIS AND RUBBISH CAUSED BY THE OPERATIONS OF THE CONTRACTOR SHALL BE REMOVED, AND THE AREA OCCUPIED DURING CONSTRUCTION ACTIVITIES SHALL BE RESTORED TO ITS ORIGINAL CONDITION, WITHIN 48 HOURS OF PROJECT COMPLETION, UNLESS OTHERWISE DIRECTED

BY THE MUNICIPALITY OR OWNER'S REPRESENTATIVE. 14. THE CONTRACTOR IS REQUIRED TO PROVIDE AND MAINTAIN EROSION AND SEDIMENT CONTROL MEASURES IN ACCORDANCE WITH THE LOCAL JURISDICTION, THE STATE OF COLORADO, URBAN DRAINAGE AND FLOOD CONTROL DISTRICT "URBAN STORM DRAINAGE CRITERIA MANUAL VOLUME 3", THE M-STANDARD PLANS OF THE COLORADO DEPARTMENT OF TRANSPORTATION, AND THE APPROVED EROSION CONTROL PLAN. JURISDICTIONAL AUTHORITY MAY REQUIRE THE CONTRACTOR TO PROVIDE ADDITIONAL EROSION CONTROL MEASURES AT THE CONTRACTOR'S EXPENSE DUE TO UNFORESEEN EROSION PROBLEMS OR IF THE PLANS DO NOT FUNCTION AS INTENDED. THE CONTRACTOR IS RESPONSIBLE FOR PROHIBITING SILT AND DEBRIS LADEN RUNOFF FROM LEAVING THE SITE. AND FOR KEEPING ALL PUBLIC AREAS FREE OF MUD AND DEBRIS. THE CONTRACTOR IS RESPONSIBLE FOR RE-ESTABLISHING FINAL GRADES AND FOR REMOVING ACCUMULATED SEDIMENTATION FROM ALL AREAS INCLUDING SWALES AND DETENTION/WATER QUALITY AREAS. CONTRACTOR SHALL REMOVE TEMPORARY EROSION CONTROL MEASURES AND REPAIR AREAS AS REQUIRED AFTER VEGETATION IS ESTABLISHED AND ACCEPTED BY OWNER AND MUNICIPALITY.

15. ADA COMPLIANCE: THE CROSS-SLOPE OF ALL WALKS MUST BE 2.0% MAX. PERPENDICULAR TO DIRECTION OF TRAVEL. MAXIMUM GRADE OF HANDICAPPED ACCESSIBLE WALKS MUST BE 5.0% MAX. IN DIRECTION OF TRAVEL MAXIMUM GRADE OF ALL HANDICAP RAMPS IS 8.3% OVER A MAXIMUM 6" RISE. MAXIMUM GRADE AT HANDICAP PARKING IS TYPICALLY 2.0% IN ALL DIRECTIONS. CONTRACTOR TO NOTIFY ENGINEER PRIOR TO PLACEMENT OF FLATWORK OF SITE CONDITIONS OR DISCREPANCIES WHICH PREVENT TYPICAL REQUIRED GRADES FROM BEING ACHIEVED. ALL RAMPS, STAIRS AND RAILING SHALL BE CONSTRUCTED IN ACCORDANCE WITH CURRENT ADA STANDARDS. HANDICAP RAMPS SHALL CONFORM TO CDOT M-STANDARDS (SEE DETAIL M-608-1, ETC.)

16. BENCHMARK INFORMATION: TOPOGRAPHIC INFORMATION WAS PROVIDED BY SCHMIDT LAND SURVEYING, INC. SEE THE TOPOGRAPHIC MAP OF BLOCK 11, FRISCO TOWN SUBDIVISION SUMMIT COUNTY, COLORADO. DATED 08/16/2017. PROJECT BENCHMARK ELEVATION AND DATUM PER SURVEY. COORDINATE AND VERIFY ALL VERTICAL AND HORIZONTAL DATA WITH REFERENCED SURVEY AND SURVEYOR, AND REPORT ANY IRREGEGULARITIES OR DISCREPANCIES TO ENGINEER PRIOR TO CONSTRUCTION.

17. HORIZONTAL CONTROL INFORMATION: HORIZONTAL CONTROL COORDINATES ARE BASED ON THE REFERENCED SURVEY AND ARE PROVIDED BY THE FOLLOWING POINTS AS SHOWN ON THE PLANS:

<CP-1 N <CP-2 N

18. BASIS OR BEARINGS: SEE PLANS. PROTECT ALL TREES AND VEGETATION. PLACE CONSTRUCTION FENCING AT DRIP LINE OF TREES AND PLANTS NEAR THE WORK ZONE. DEEP WATER TREES WEEKLY. HAND EXCAVATION REQUIRED AT ROOT ZONES WHERE PROPOSED PAVING OR UTILITY WORK IS WITHIN DRIPLINE OF TREES.

19. THE CONTRACTOR SHALL FURNISH THE TOWN OF FRISCO, UTILITY OWNERS, ENGINEER AND OWNER WITH A SET OF CONSTRUCTION RECORD DRAWINGS MARKED "AS-BUILT". THE PLANS SHALL SHOW FINAL PAVEMENT AND, FLOW LINE ELEVATIONS, CONTOURS AT POND/DRAINAGE FEATURES (AS SURVEYED AND CERTIFIED BY A COLORADO P.L.S.), MANHOLE, PIPE, AND INLET LOCATIONS, INVERTS, GRADE ELEVATIONS, AND SIZES OF ALL UTILITIES, AND ANY VARIATIONS FROM THE APPROVED PLAN.


CONSULTING ENGINEERS


PO Box 186 47 Cooper Creek Way Suite 32 Winter Park, CO 80482 970.722.767 www.jvajva.com Boulder • Fort Collins • Winter Park Glenwood Springs • Denver

DESIGNED BY: DRAWN BY: CHECKED BY: JOB #: 2789c DATE: 9/6/2017 © JVA, INC.

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2789c

- 1. THESE PLANS SHALL NOT BE UTILIZED FOR CONSTRUCTION OR PERMITTING UNLESS STATED FOR SUCH USE IN THE TITLE BLOCK.
- 2. DRAWINGS ARE INTENDED TO BE PRINTED ON 24" X 36" PAPER. PRINTING THESE DRAWINGS AT A DIFFERENT SIZE WILL IMPACT THE SCALE. VERIFY THE GRAPHIC SCALE BEFORE REFERENCING ANY MEASUREMENTS ON THESE SHEETS. THE RECIPIENT OF THESE DRAWINGS SHALL BE RESPONSIBLE FOR ANY ERRORS RESULTING FROM INCORRECT PRINTING, COPYING, OR ANY OTHER CHANGES THAT ALTER THE SCALE OF THE DRAWINGS.
- 3. VERIFY ALL PLAN DIMENSIONS PRIOR TO START OF CONSTRUCTION. NOTIFY THE OWNER'S REPRESENTATIVE TO ADDRESS ANY QUESTIONS OR CLARIFY ANY DISCREPANCIES.
- 4. WRITTEN DIMENSIONS TAKE PRECEDENCE OVER SCALED DIMENSIONS.
- 5. SUBMIT A CHANGE ORDER FOR APPROVAL FOR ANY CHANGES TO WORK SCOPE RESULTING FROM FIELD CONDITIONS OR DIRECTION BY OWNER'S REPRESENTATIVE WHICH REQUIRE ADDITIONAL COST TO THE OWNER PRIOR TO PERFORMANCE OF WORK.
- 6. IF A GEOTECHNICAL SOILS REPORT IS NOT AVAILABLE AT THE TIME OF CONSTRUCTION, NORRIS DESIGN RECOMMENDS A REPORT BE AUTHORIZED BY THE OWNER AND THAT ALL RECOMMENDATIONS OF THE REPORT ARE FOLLOWED DURING CONSTRUCTION. THE CONTRACTOR SHALL USE THESE CONTRACT DOCUMENTS AS A BASIS FOR THE BID. IF THE OWNER ELECTS TO PROVIDE A GEOTECHNICAL REPORT, THE CONTRACTOR SHALL REVIEW THE REPORT AND SUBMIT AN APPROPRIATE CHANGE ORDER TO THE OWNER'S REPRESENTATIVE IF ADDITIONAL COSTS ARE REQUESTED.
- 7. CONTRACTOR SHALL CONFIRM THAT SITE CONDITIONS ARE SIMILAR TO THE PLANS, WITHIN TOLERANCES STATED IN THE CONTRACT DOCUMENTS, AND SATISFACTORY TO THE CONTRACTOR PRIOR TO START OF WORK. SHOULD SITE CONDITIONS BE DIFFERENT THAN REPRESENTED ON THE PLANS OR UNSATISFACTORY TO THE CONTRACTOR, THE CONTRACTOR SHALL CONTACT THE OWNER'S REPRESENTATIVE FOR CLARIFICATION AND FURTHER DIRECTION.
- 8. CONTRACTOR IS RESPONSIBLE TO PAY FOR, AND OBTAIN, ANY REQUIRED APPLICATIONS, PERMITTING, LICENSES, INSPECTIONS AND METERS ASSOCIATED WITH WORK.
- 9. THE CONTRACTOR SHALL BE RESPONSIBLE FOR ANY FINES OR PENALTIES ASSESSED TO THE OWNER RELATING TO ANY VIOLATIONS OR NON-CONFORMANCE WITH THE PLANS, SPECIFICATIONS, CONTRACT DOCUMENTS, JURISDICTIONAL CODES, AND REGULATORY AGENCIES.
- 10. THE CONTRACTOR SHALL BE RESPONSIBLE FOR COORDINATION OF ALL UTILITY LOCATES PRIOR TO ANY EXCAVATION. REFER TO ENGINEERING UTILITY PLANS FOR ALL PROPOSED UTILITY LOCATIONS AND DETAILS. NOTIFY OWNER'S REPRESENTATIVE IF EXISTING OR PROPOSED UTILITIES INTERFERE WITH THE ABILITY TO PERFORM WORK.
- 11. UNLESS IDENTIFIED ON THE PLANS FOR DEMOLITION OR REMOVAL, THE CONTRACTOR IS RESPONSIBLE FOR THE COST TO REPAIR UTILITIES, ADJACENT OR EXISTING LANDSCAPE, ADJACENT OR EXISTING PAVING, OR ANY PUBLIC AND PRIVATE PROPERTY THAT IS DAMAGED BY THE CONTRACTOR OR THEIR SUBCONTRACTOR'S OPERATIONS DURING INSTALLATION, ESTABLISHMENT OR DURING THE SPECIFIED MAINTENANCE PERIOD. ALL DAMAGES SHALL BE REPAIRED TO PRE-CONSTRUCTION CONDITIONS AS DETERMINED BY THE OWNER'S REPRESENTATIVE. CONTRACTOR SHALL BE RESPONSIBLE FOR LOGGING ANY DAMAGES PRIOR TO START OF CONSTRUCTION AND DURING THE CONTRACT PERIOD.
- 12. ALL WORK SHALL BE CONFINED TO THE AREA WITHIN THE CONSTRUCTION LIMITS AS SHOWN ON THE PLANS. ANY AREAS OR IMPROVEMENTS DISTURBED OUTSIDE THESE LIMITS SHALL BE RETURNED TO THEIR ORIGINAL CONDITION AT THE CONTRACTOR'S EXPENSE. IN THE EVENT THE CONTRACTOR REQUIRES A MODIFICATION TO THE CONSTRUCTION LIMITS, WRITTEN PERMISSION MUST BE OBTAINED FROM THE OWNER'S REPRESENTATIVE PRIOR TO ANY DISTURBANCE OUTSIDE OF THE LIMITS OF WORK.
- 13. THE CONTRACTOR SHALL BE RESPONSIBLE FOR THE REPAIR OF ANY OF THEIR TRENCHES OR EXCAVATIONS THAT SETTLE.
- 14. THE CONTRACTOR SHALL BE RESPONSIBLE TO PREPARE AND SUBMIT A TRAFFIC CONTROL PLAN TO THE APPROPRIATE JURISDICTIONAL AGENCIES AND THE OWNER'S REPRESENTATIVE IF THEIR WORK AND OPERATIONS AFFECT OR IMPACT THE PUBLIC RIGHTS-OF-WAY. OBTAIN APPROVAL PRIOR TO ANY WORK WHICH AFFECTS OR IMPACTS THE PUBLIC RIGHTS-OF-WAY. THE CONTRACTOR SHALL BE RESPONSIBLE FOR ANY FINES OR PENALTIES ASSESSED TO THE OWNER RELATING TO THIS REQUIREMENT DURING THE CONTRACT PERIOD.
- 15. SIGHT TRIANGLES AND SIGHT LINES SHALL REMAIN UNOBSTRUCTED BY EQUIPMENT, CONSTRUCTION MATERIALS, PLANT MATERIAL OR ANY OTHER VISUAL OBSTACLE DURING THE CONTRACT PERIOD AND AT MATURITY OF PLANTS PER LOCAL JURISDICTIONAL REQUIREMENTS. NO PLANT MATERIAL OTHER THAN GROUND COVER IS ALLOWED TO BE PLANTED ADJACENT TO FIRE HYDRANTS AS STIPULATED BY JURISDICTIONAL REQUIREMENTS.
- 16. COORDINATE SITE ACCESS, STAGING, STORAGE AND CLEANOUT AREAS WITH OWNER'S REPRESENTATIVE.
- 17. CONTRACTOR IS RESPONSIBLE FOR PROVIDING TEMPORARY SAFETY FENCING AND BARRIERS AROUND ALL IMPROVEMENTS SUCH AS WALLS, PLAY STRUCTURES, EXCAVATIONS, ETC. ASSOCIATED WITH THEIR WORK UNTIL SUCH FACILITIES ARE COMPLETELY INSTALLED PER THE PLANS, SPECIFICATIONS AND MANUFACTURER'S RECOMMENDATIONS.
- 18. CONTRACTOR SHALL BE RESPONSIBLE FOR PROTECTION OF THEIR MATERIAL STOCK PILES AND WORK FROM VANDALISM, EROSION OR UNINTENDED DISTURBANCE DURING THE CONSTRUCTION PERIOD AND UNTIL FINAL ACCEPTANCE IS ISSUED.
- 19. THE CONTRACTOR SHALL KNOW, UNDERSTAND AND ABIDE BY ANY STORM WATER POLLUTION PREVENTION PLAN (SWPPP) ASSOCIATED WITH THE SITE. IF A STORM WATER POLLUTION PREVENTION PLAN IS NOT PROVIDED BY THE OWNER'S REPRESENTATIVE, REQUEST A COPY BEFORE PERFORMANCE OF ANY SITE WORK.
- 20. MAINTAIN ANY STORM WATER MANAGEMENT FACILITIES THAT EXIST ON SITE FOR FULL FUNCTIONALITY. THE CONTRACTOR SHALL INSTALL AND MAINTAIN ANY NEW STORM WATER MANAGEMENT FACILITIES THAT ARE IDENTIFIED IN THE SCOPE OF WORK TO FULL FUNCTIONALITY. THE CONTRACTOR SHALL BE RESPONSIBLE FOR ANY FINES OR PENALTIES ASSESSED TO THE OWNER FOR FAILURE TO MAINTAIN STORM WATER MANAGEMENT FACILITIES DURING THE CONTRACT PERIOD.
- 21. THE CONTRACTOR SHALL PREVENT SEDIMENT, DEBRIS AND ALL OTHER POLLUTANTS FROM EXITING THE SITE OR ENTERING THE STORM SEWER SYSTEM DURING ALL DEMOLITION OR CONSTRUCTION OPERATIONS THAT ARE PART OF THIS PROJECT. THE CONTRACTOR SHALL BE RESPONSIBLE FOR ANY FINES OR PENALTIES ASSESSED TO THE OWNER RELATING TO THESE REQUIREMENTS DURING THEIR CONTRACTED COURSE OF WORK.
- 22. THE CONTRACTOR SHALL BE RESPONSIBLE TO PREVENT ANY IMPACTS TO ADJACENT WATERWAYS, WETLANDS, OR OTHER ENVIRONMENTALLY SENSITIVE AREAS RESULTING FROM WORK DONE AS PART OF THIS PROJECT. THE CONTRACTOR SHALL BE RESPONSIBLE FOR ANY FINES OR PENALTIES ASSESSED TO THE OWNER RELATING TO THESE STANDARDS DURING THEIR CONTRACTED COURSE OF WORK.
- 23. THE CONTRACTOR AND/OR THEIR AUTHORIZED AGENTS SHALL INSURE THAT ALL LOADS OF CONSTRUCTION MATERIAL IMPORTED TO OR EXPORTED FROM THE PROJECT SITE SHALL BE PROPERLY COVERED TO PREVENT LOSS OF MATERIAL DURING TRANSPORT.

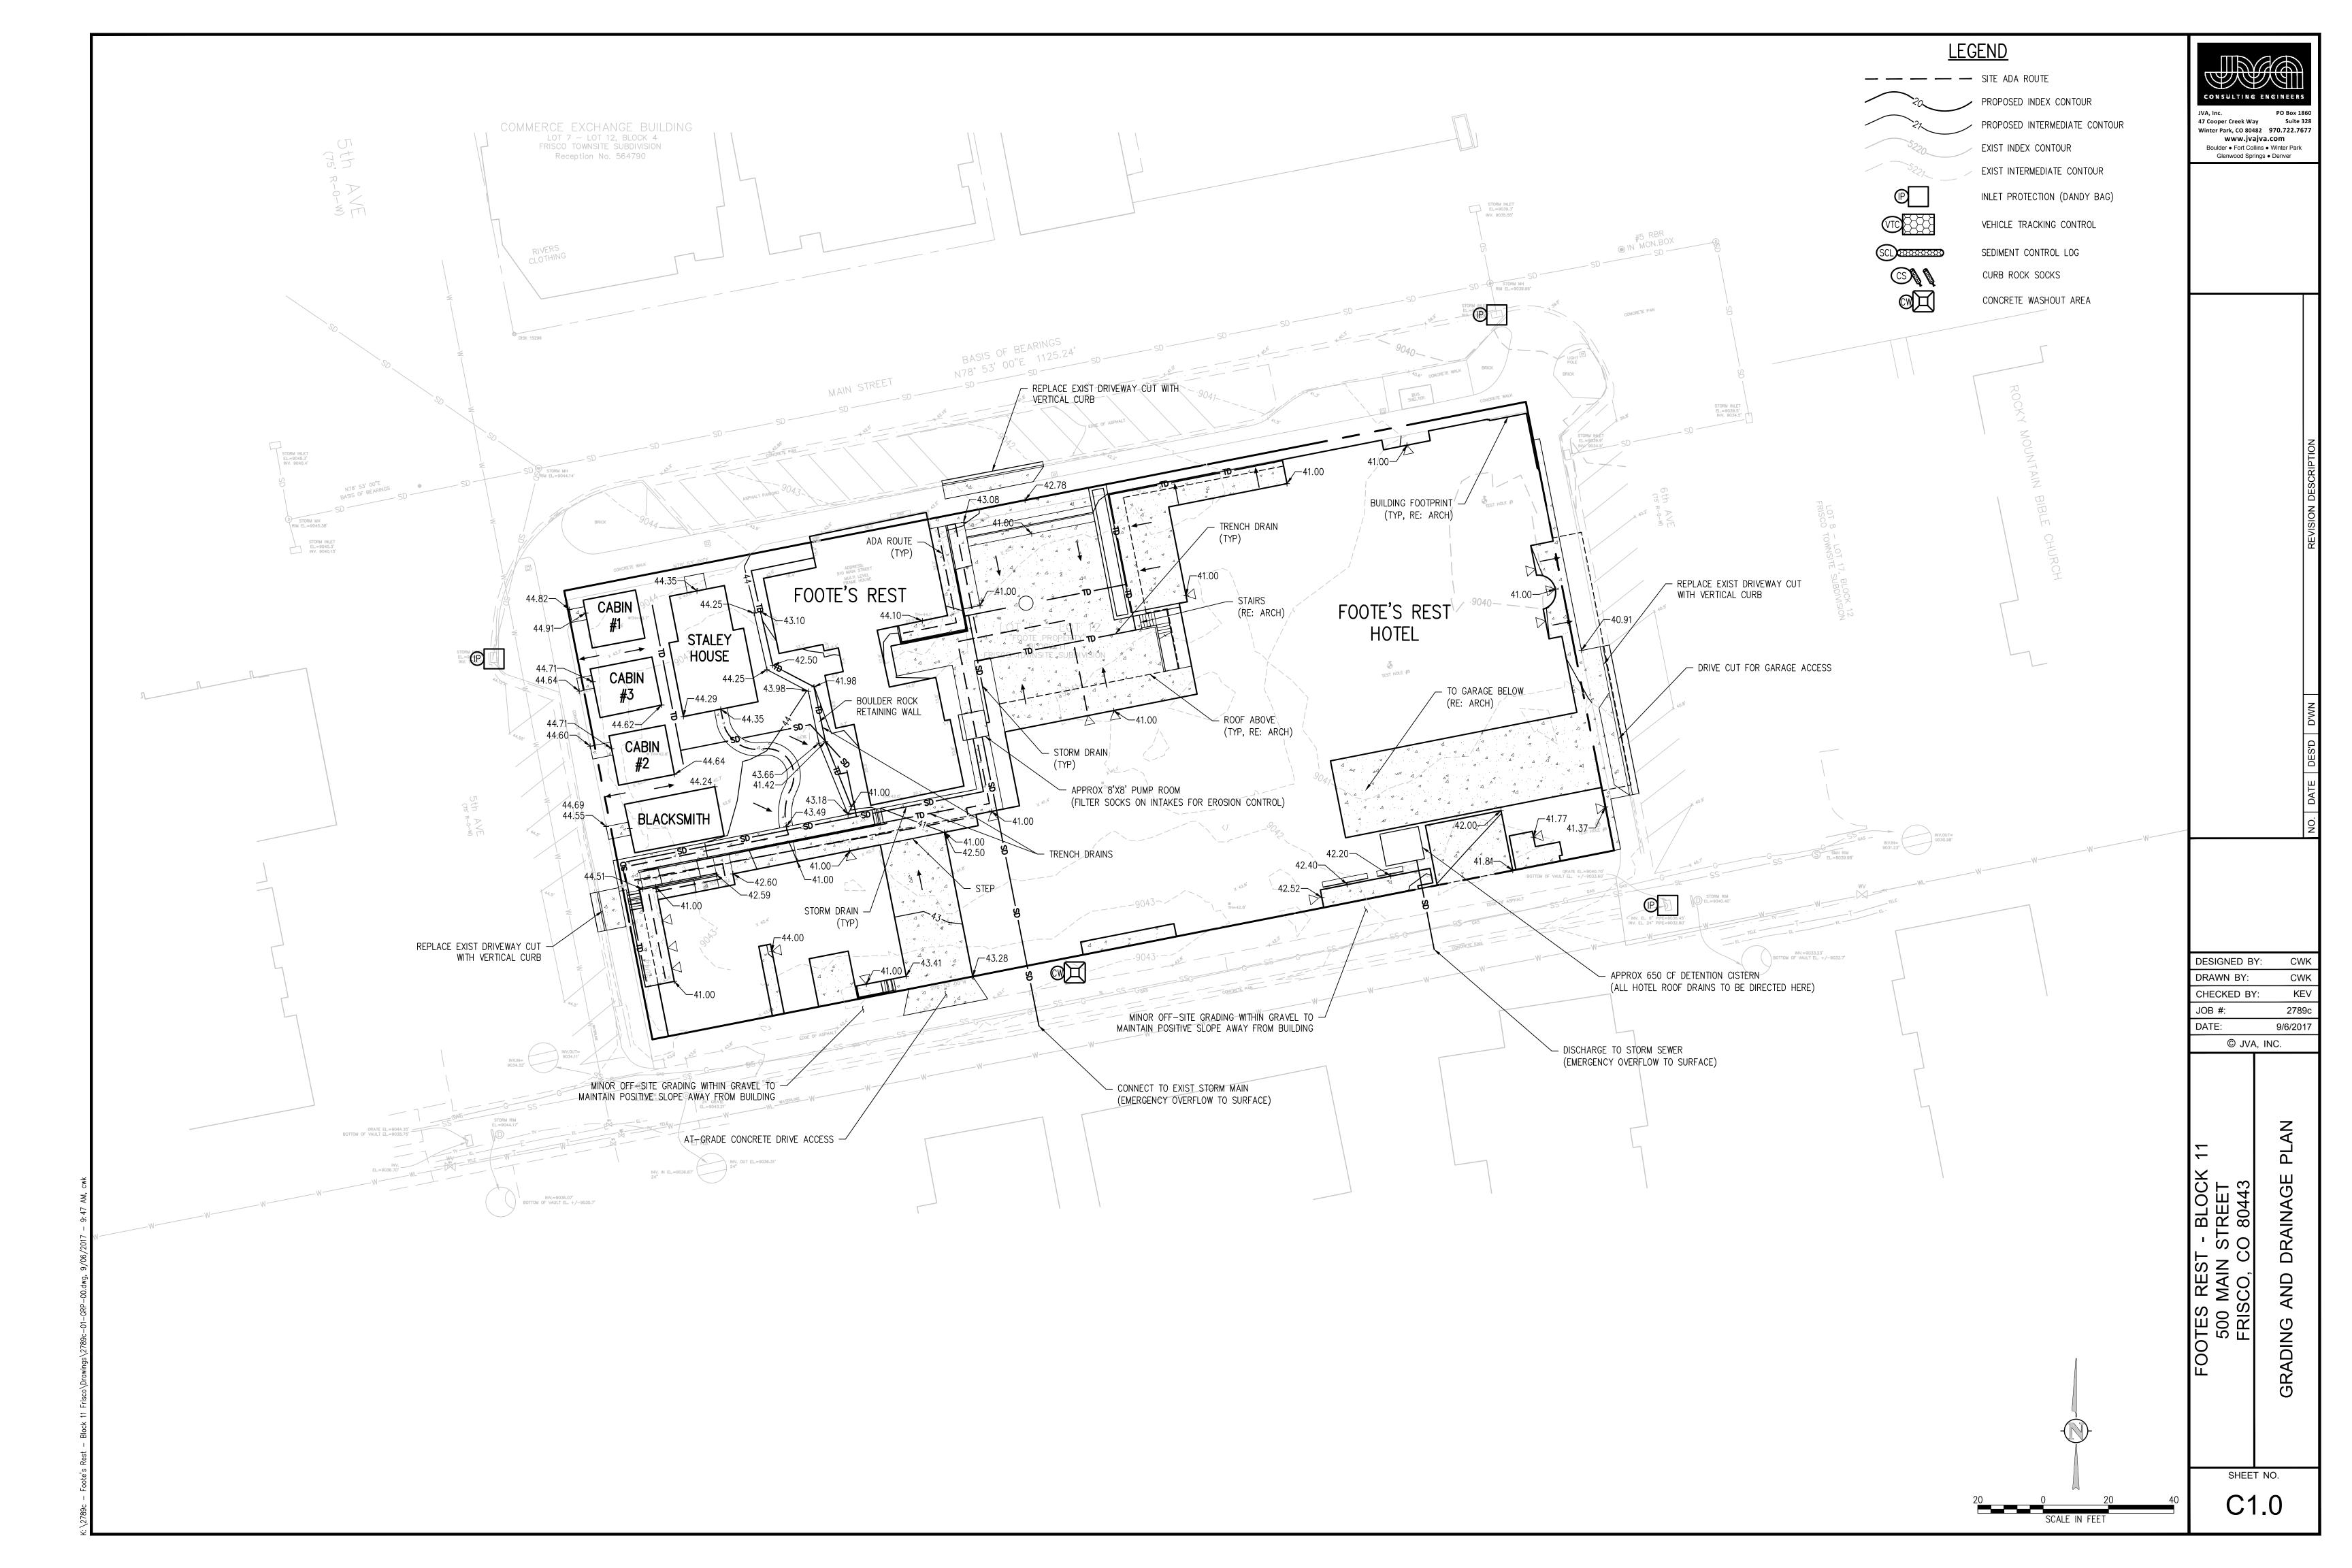 TRANSPORTATION METHODS ON PUBLIC RIGHT-OF WAYS SHALL CONFORM TO JURISDICTIONAL REQUIREMENTS. THE CONTRACTOR SHALL BE RESPONSIBLE FOR ANY FINES OR PENALTIES ASSESSED TO THE OWNER RELATING TO THESE REQUIREMENTS.
- 24. THE CLEANING OF EQUIPMENT IS PROHIBITED AT THE JOB SITE UNLESS AUTHORIZED BY THE OWNER'S REPRESENTATIVE IN A DESIGNATED AREA. THE DISCHARGE OF WATER, WASTE CONCRETE, POLLUTANTS, OR OTHER MATERIALS SHALL ONLY OCCUR IN AREAS DESIGNED FOR SUCH USE AND APPROVED BY THE OWNER'S REPRESENTATIVE.
- 25. THE CLEANING OF CONCRETE EQUIPMENT IS PROHIBITED AT THE JOB SITE EXCEPT IN DESIGNATED CONCRETE WASHOUT AREAS. THE DISCHARGE OF WATER CONTAINING WASTE CONCRETE IN THE STORM SEWER IS PROHIBITED.

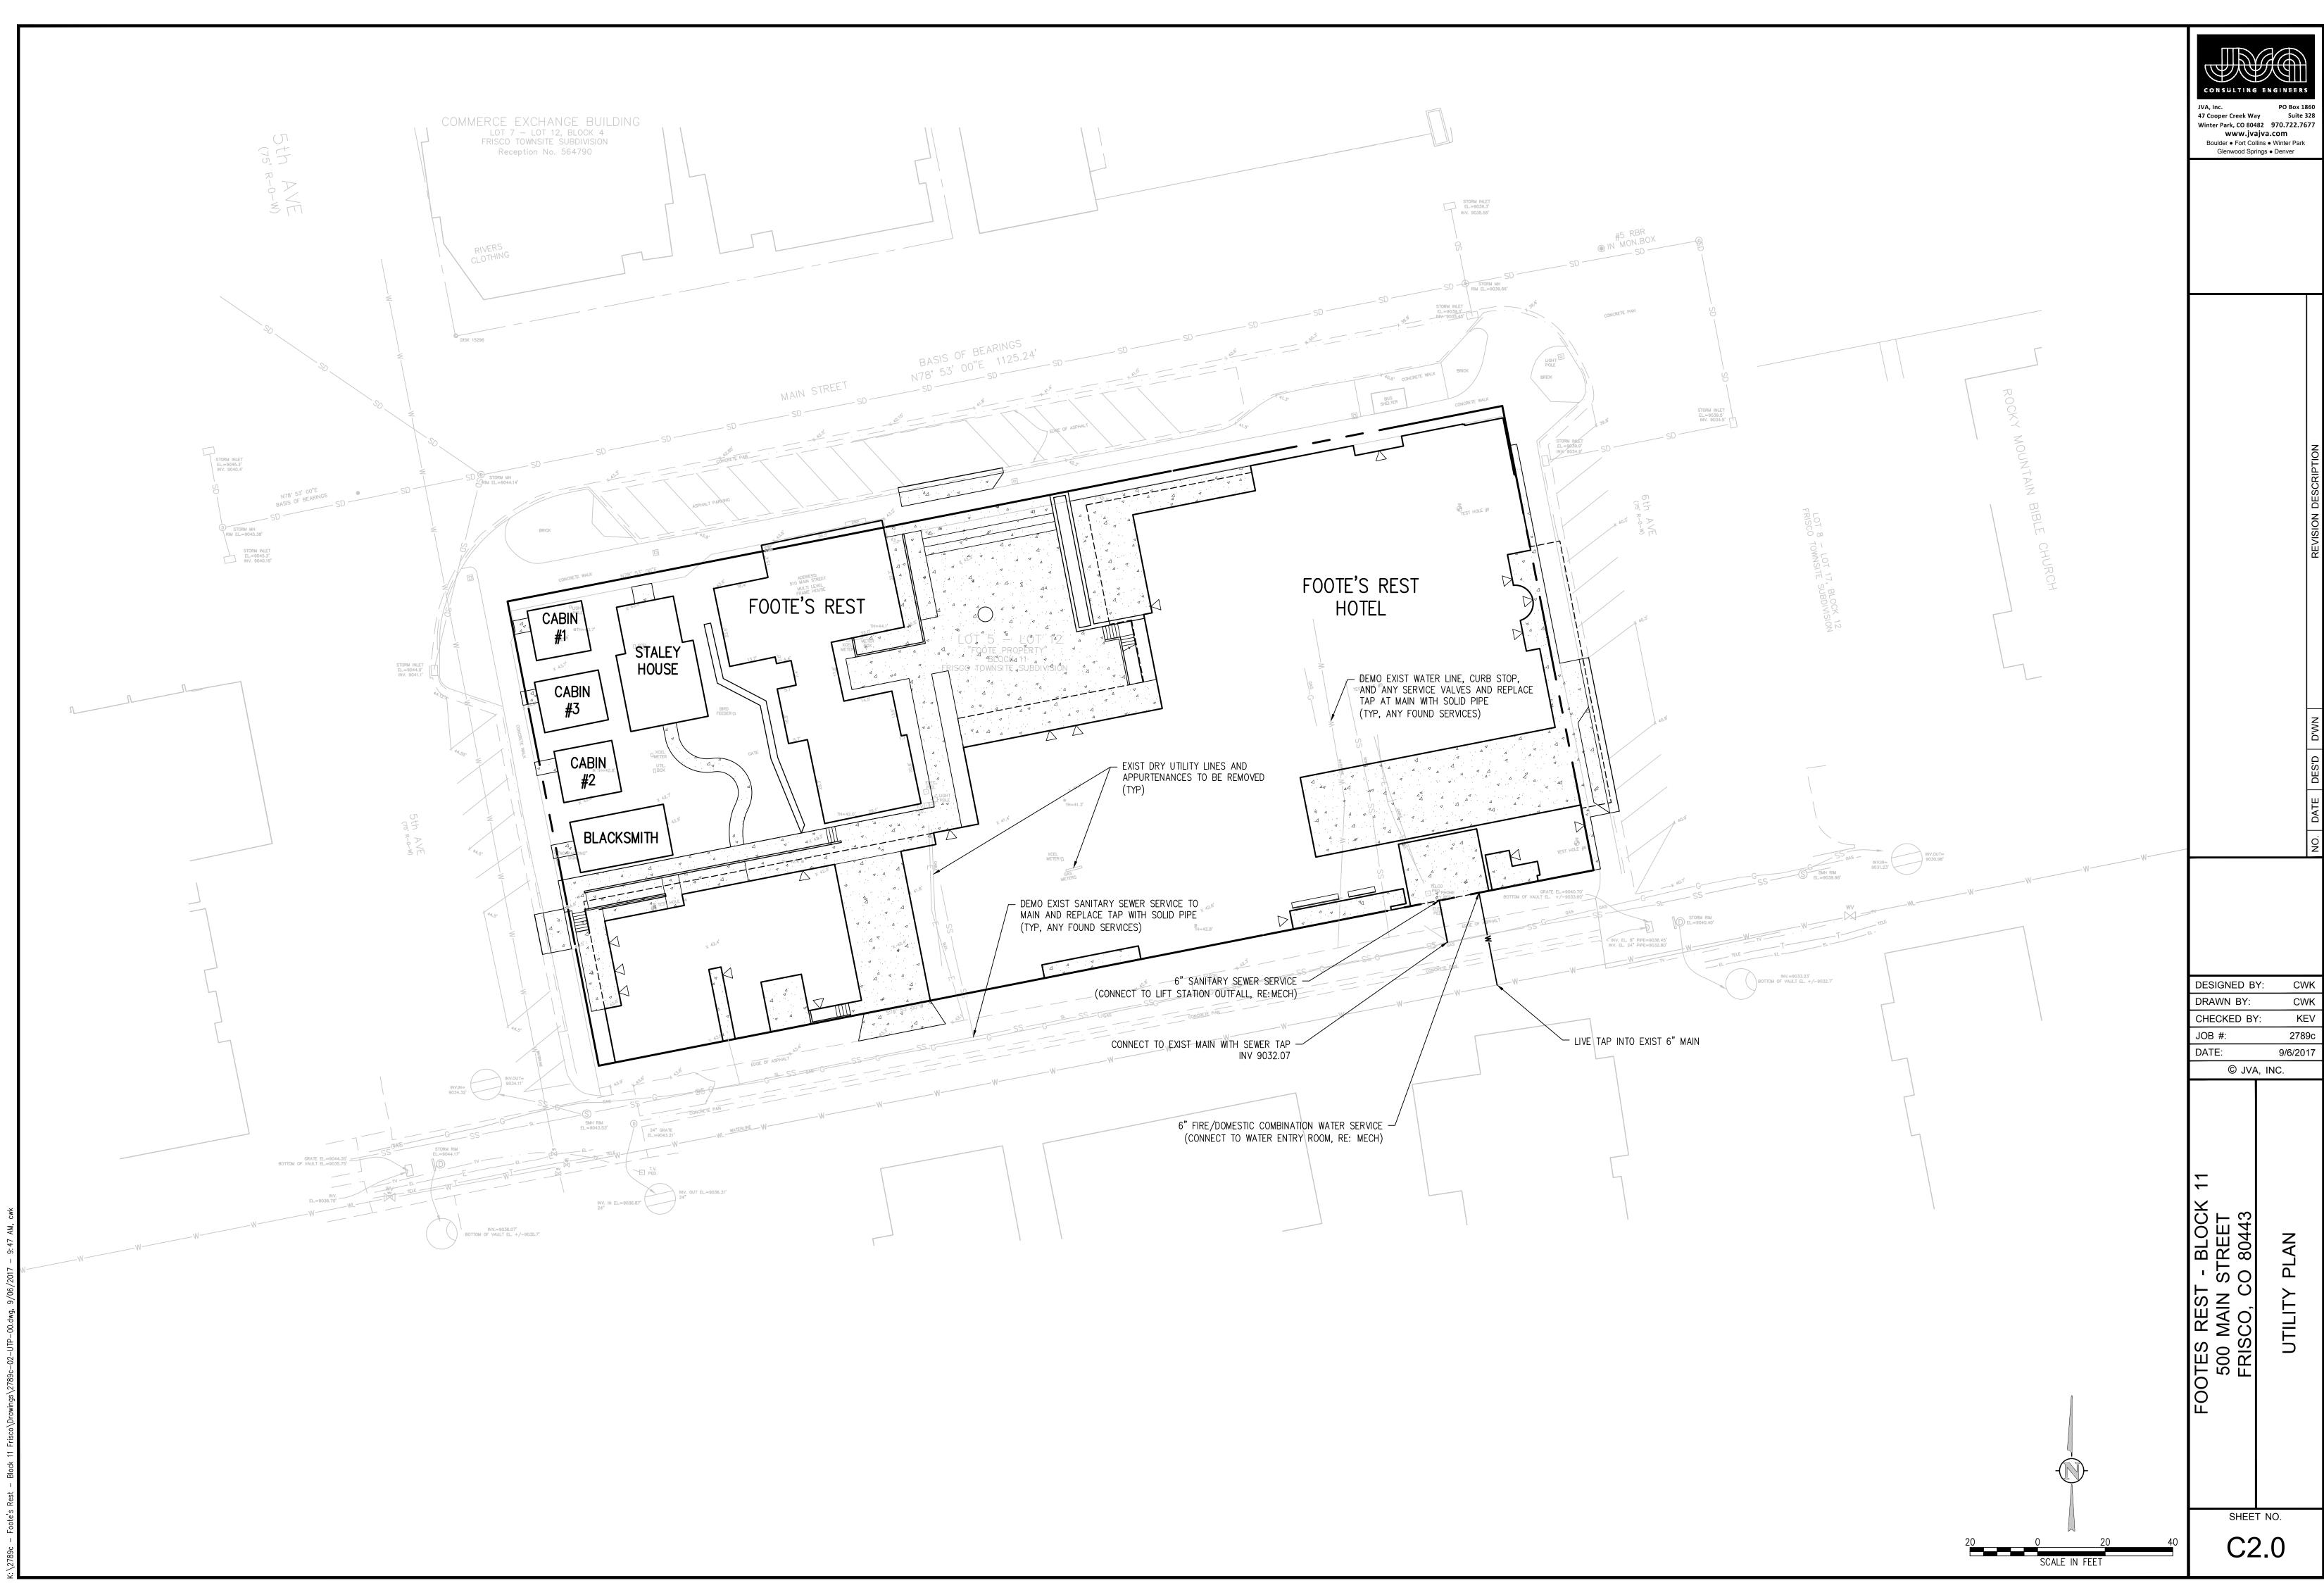- 26. MAINTENANCE ACCESS BENCHES: IF MAINTENANCE BENCHES OR ACCESS ROADS EXIST ON SITE AND ARE NOT INTENDED TO BE MODIFIED AS PART OF THE PLANS, THE CONTRACTOR SHALL MINIMIZE DISTURBANCE TO THE BENCHES OR ACCESS ROADS DURING CONSTRUCTION. ANY BENCHES OR ACCESS ROADS DISTURBED BY THE CONTRACTOR SHALL BE REPAIRED/RESTORED TO THEIR ORIGINAL CONDITION. THE CONTRACTOR SHALL MAINTAIN ACCESS TO ALL EXISTING BENCHES AND ACCESS ROADS DURING THE CONSTRUCTION PERIOD. IF ACCESS NEEDS TO BE BLOCKED FOR ANY REASON, THE CONTRACTOR SHALL NOTIFY THE OWNER'S REPRESENTATIVE FOR APPROVAL PRIOR TO INTERRUPTION OF ACCESS.
- 27. LOCAL, STATE AND FEDERAL JURISDICTIONAL REQUIREMENTS, RESTRICTIONS OR PROCEDURES SHALL SUPERSEDE THESE PLANS, NOTES AND SPECIFICATIONS WHEN MORE STRINGENT. NOTIFY THE OWNER'S REPRESENTATIVE IF CONFLICTS OCCUR.

LAYOUT NOTES

- 1. WRITTEN DIMENSIONS WILL TAKE PRECEDENCE OVER SCALED DIMENSIONS.
- 2. CURVED WALKS AND CURB EDGES ARE INTENDED TO BE CONSTRUCTED WITH SMOOTH FLOWING CURVES. ANYTHING OTHER THAN SMOOTH FLOWING CURVES WILL BE REJECTED
- 3. THE CONTRACTOR SHALL OBTAIN, AT HIS EXPENSE, ALL PERMITS WHICH ARE NECESSARY TO PERFORM THE PROPOSED WORK.
- 4. THE CONTRACTOR SHALL PROVIDE A STAKED LAYOUT OF ALL SITE IMPROVEMENTS FOR INSPECTION BY THE OWNER'S REPRESENTATIVE AND MAKE MODIFICATIONS AS REQUIRED AT NO ADDITIONAL COST TO THE OWNER.
- 5. THE CONTRACTOR SHALL INSTALL SLEEVING FOR IRRIGATION IMPROVEMENTS PRIOR TO INSTALLING CONCRETE FLATWORK. REFER TO IRRIGATION PLANS.
- 6. LAY OUT WALKS, SCORE JOINTS AND PAVING PATTERNS AS CLOSELY AS POSSIBLE TO PLANS, DETAILS, AND SPECIFICATIONS. DO NOT DEVIATE FROM PLANS UNLESS SPECIFIC APPROVAL IS OBTAINED FROM THE OWNER'S REPRESENTATIVE.
- 7. ALL WORK SHALL BE CONFINED TO THE AREA WITHIN THE CONSTRUCTION LIMITS AS SHOWN ON THE PLANS. ANY AREAS OR IMPROVEMENTS DISTURBED OUTSIDE THESE LIMITS SHALL BE RETURNED TO THEIR ORIGINAL CONDITION AT THE CONTRACTOR'S EXPENSE. IN THE EVENT THE CONTRACTOR REQUIRES A MODIFICATION TO THE CONSTRUCTION LIMITS, WRITTEN PERMISSION MUST BE OBTAINED FROM THE LANDSCAPE ARCHITECT PRIOR TO ANY DISTURBANCE OUTSIDE OF THE LIMITS OF WORK. SEE TECHNICAL SPECIFICATIONS.
- 8. CONTRACTOR IS RESPONSIBLE FOR SUPERVISING ALL PAVEMENT DURING THE CURING PROCESS.

EROSION NOTES

- THE OWNER, SITE DEVELOPER, CONTRACTOR AND/OR THEIR AUTHORIZED AGENTS SHALL REMOVE ALL SEDIMENT, MUD, AND CONSTRUCTION DEBRIS THAT MAY ACCUMULATE IN THE FLOW LINE AND THE PUBLIC RIGHTS-OF-WAY OF THE TOWN OF FRISCO, COLORADO, AS A RESULT OF THIS SITE DEVELOPMENT. SAID REMOVAL SHALL BE CONDUCTED IN A TIMELY MANNER.
- 2. THE CONTRACTOR SHALL PREVENT SEDIMENT, DEBRIS AND ALL OTHER POLLUTANTS FROM ENTERING THE STORM SEWER SYSTEM DURING ALL DEMOLITION OR CONSTRUCTION OPERATIONS THAT ARE PART OF THIS PROJECT.
- 3. THE CONTRACTOR SHALL BE HELD RESPONSIBLE FOR REMEDIATION OF ANY ADVERSE IMPACTS TO ADJACENT WATERWAYS, WETLANDS, ETC., RESULTING FROM WORK DONE AS PART OF THIS PROJECT.
- 4. THE DEVELOPER, GENERAL CONTRACTOR, GRADING CONTRACTOR AND/OR THEIR AUTHORIZED AGENTS SHALL INSURE THAT ALL LOADS OF CUT AND FILL MATERIAL IMPORTED TO OR EXPORTED FROM THIS SITE SHALL BE PROPERLY COVERED TO PREVENT LOSS OF MATERIAL DURING TRANSPORT ON PUBLIC RIGHT-OF WAYS.
- 5. THE USE OF REBAR, STEEL STAKES, OR STEEL FENCE POSTS TO STAKE DOWN STRAW OR HAY BALES OR TO SUPPORT SILT FENCING USED AS AN EROSION CONTROL MEASURE IS PROHIBITED.
- 6. THE CLEANING OF CONCRETE TRUCK DELIVERY CHUTES IS PROHIBITED AT THE JOB SITE. THE DISCHARGE OF WATER CONTAINING WASTE CONCRETE TO THE STORM SEWER SYSTEM IS PROHIBITED.
- 7. THE CONTRACTOR SHALL PROTECT ALL STORM SEWER FACILITIES ADJACENT TO ANY LOCATION WHERE PAVEMENT CUTTING OPERATIONS INVOLVING WHEEL CUTTING, SAW CUTTING, OR ABRASIVE WATER JET CUTTING ARE TO TAKE PLACE. THE CONTRACTOR SHALL REMOVE AND PROPERLY DISPOSE OF ALL WASTE PRODUCTS GENERATED BY SAID CUTTING OPERATIONS ON A DAILY BASIS.



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DATE:

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SHEET TITLE:
GENERAL
NOTES

L-001

PRODUCTS PRIOR TO INSTALLATION.

2. THE CONTRACTOR IS RESPONSIBLE FOR VERIFYING ALL PLANT QUANTITIES. GRAPHIC QUANTITIES TAKES PRECEDENCE OVER WRITTEN QUANTITIES

- THE OWNER'S REPRESENTATIVE RESERVES THE RIGHT TO INSPECT AND TAG ALL PLANT MATERIAL PRIOR TO SHIPPING TO THE SITE. IN ALL CASES, THE OWNER'S REPRESENTATIVE MAY REJECT PLANT MATERIAL AT THE SITE IF MATERIAL IS DAMAGED, DISEASED, OR DECLINING IN HEALTH AT THE TIME OF ONSITE INSPECTIONS OR IF THE PLANT MATERIAL DOES NOT MEET THE MINIMUM SPECIFIED STANDARD IDENTIFIED ON THE PLANS AND IN THE SPECIFICATIONS. THE CONTRACTOR SHALL COORDINATE WITH THE OWNER'S REPRESENTATIVE FOR INSPECTION AND APPROVAL OF ALL MATERIALS AND
- 4. THE OWNER'S REPRESENTATIVE MAY ELECT TO UPSIZE PLANT MATERIAL AT THEIR DISCRETION BASED ON SELECTION, AVAILABILITY, OR TO ENHANCE SPECIFIC AREAS OF THE PROJECT. THE CONTRACTOR SHALL VERIFY PLANT MATERIAL SIZES WITH OWNER'S REPRESENTATIVE PRIOR TO PURCHASING, SHIPPING OR STOCKING OF PLANT MATERIALS. SUBMIT CHANGE ORDER REQUEST TO OWNER'S REPRESENTATIVE FOR APPROVAL IF ADDITIONAL COST IS REQUESTED BY THE CONTRACTOR PRIOR TO INSTALLATION. RE-STOCKING CHARGES WILL NOT BE APPROVED IF THE CONTRACTOR FAILS TO SUBMIT A REQUEST FOR MATERIAL CHANGES.
- 5. THE CONTRACTOR SHALL WARRANTY ALL CONTRACTED WORK AND MATERIALS FOR A PERIOD OF ONE YEAR AFTER SUBSTANTIAL COMPLETION HAS BEEN ISSUED BY THE OWNER'S REPRESENTATIVE FOR THE ENTIRE PROJECT UNLESS OTHERWISE SPECIFIED IN THE CONTRACT DOCUMENTS OR SPECIFICATIONS.
- 6. REFER TO IRRIGATION PLANS FOR LIMITS AND TYPES OF IRRIGATION DESIGNED FOR THE LANDSCAPE. IN NO CASE SHALL IRRIGATION BE EMITTED WITHIN THE MINIMUM DISTANCE FROM BUILDING OR WALL FOUNDATIONS AS STIPULATED IN THE GEOTECHNICAL REPORT ALL IRRIGATION DISTRIBUTION LINES, HEADS AND EMITTERS SHALL BE KEPT OUTSIDE THE MINIMUM DISTANCE AWAY FROM ALL BUILDING AND WALL FOUNDATIONS AS STIPULATED IN THE GEOTECHNICAL REPORT.
- 7. LANDSCAPE MATERIAL LOCATIONS SHALL HAVE PRECEDENCE OVER IRRIGATION MAINLINE AND LATERAL LOCATIONS. COORDINATE INSTALLATION OF IRRIGATION EQUIPMENT SO THAT IT DOES NOT INTERFERE WITH THE PLANTING OF TREES OR OTHER LANDSCAPE MATERIAL
- 8. THE LANDSCAPE CONTRACTOR SHALL BE RESPONSIBLE FOR ENSURING POSITIVE DRAINAGE EXISTS IN ALL LANDSCAPE AREAS. SURFACE DRAINAGE ON LANDSCAPE AREAS SHALL NOT FLOW TOWARD STRUCTURES AND FOUNDATIONS. MAINTAIN SLOPE AWAY FROM FOUNDATIONS PER THE GEOTECHNICAL REPORT RECOMMENDATIONS. ALL LANDSCAPE AREAS BETWEEN WALKS AND CURBS SHALL DRAIN FREELY TO THE CURB UNLESS OTHERWISE IDENTIFIED ON THE GRADING PLAN. IN NO CASE SHALL THE GRADE, TURF THATCH, OR OTHER LANDSCAPE MATERIALS DAM WATER AGAINST WALKS. MINIMUM SLOPES ON LANDSCAPE AREAS SHALL BE 2%; MAXIMUM SLOPE SHALL BE 25% UNLESS SPECIFICALLY IDENTIFIED ON THE PLANS OR APPROVED BY THE OWNER'S REPRESENTATIVE.
- PRIOR TO INSTALLATION OF PLANT MATERIALS. AREAS THAT HAVE BEEN COMPACTED OR DISTURBED BY CONSTRUCTION ACTIVITY SHALL BE THOROUGHLY LOOSENED TO A DEPTH OF 8" - 12" AND AMENDED PER SPECIFICATIONS.
- 10. ALL LANDSCAPED AREAS ARE TO RECEIVE ORGANIC SOIL PREPARATION AS NOTED IN THE TECHNICAL SPECIFICATIONS.
- TREES SHALL NOT BE LOCATED IN DRAINAGE SWALES. DRAINAGE AREAS. OR UTILITY EASEMENTS. CONTACT OWNER'S REPRESENTATIVE FOR RELOCATION OF PLANTS IN QUESTIONABLE AREAS PRIOR TO INSTALLATION.
- 12. THE CENTER OF EVERGREEN TREES SHALL NOT BE PLACED CLOSER THAN 8' AND THE CENTER OF ORNAMENTAL TREES CLOSER THAN 6' FROM A SIDEWALK, STREET OR DRIVE LANE. EVERGREEN TREES SHALL NOT BE LOCATED ANY CLOSER THAN 15' FROM IRRIGATION ROTOR HEADS. NOTIFY OWNER'S REPRESENTATIVE IF TREE LOCATIONS CONFLICT WITH THESE STANDARDS FOR FURTHER DIRECTION.
- 13. ALL EVERGREEN TREES SHALL BE FULLY BRANCHED TO THE GROUND AND SHALL NOT EXHIBIT SIGNS OF ACCELERATED GROWTH AS DETERMINED BY THE OWNER'S REPRESENTATIVE.
- 14. ALL TREES ARE TO BE STAKED AND GUYED PER DETAILS FOR A PERIOD OF 3 YEARS. THE CONTRACTOR SHALL BE RESPONSIBLE FOR REMOVING STAKES AT THE END OF 3 YEARS FROM ACCEPTANCE OF LANDSCAPE INSTALLATION BY THE OWNER'S REPRESENTATIVE. OBTAIN APPROVAL BY OWNER'S REPRESENTATIVE PRIOR TO REMOVAL
- 15. ALL TREES INSTALLED ABOVE RETAINING WALLS UTILIZING GEO-GRID MUST BE HAND DUG TO PROTECT GEO-GRID. IF GEO-GRID MUST BE CUT TO INSTALL TREES, APPROVAL MUST BE GIVEN BY OWNER'S REPRESENTATIVE PRIOR TO DOING WORK.

- 16. ALL TREES IN SEED OR TURF AREAS SHALL RECEIVE MULCH RINGS. OBTAIN APPROVAL FROM OWNER'S REPRESENTATIVE FOR ANY TREES THAT WILL NOT BE MULCHED FOR EXCESSIVE MOISTURE REASONS.
- 17. SHRUB, GROUNDCOVER AND PERENNIAL BEDS ARE TO BE CONTAINED BY 4" x 14 GAUGE GREEN, ROLL TOP, INTERLOCKING TYPE EDGER, RYERSON OR EQUAL. EDGER IS NOT REQUIRED WHEN ADJACENT TO CURBS, WALLS, WALKS OR SOLID FENCES WITHIN 3" OF PRE-MULCHED FINAL GRADE. EDGER SHALL NOT BE REQUIRED TO SEPARATE MULCH TYPES UNLESS SPECIFIED ON THE PLANS.
- ALL SHRUB BEDS ARE TO BE MULCHED WITH MIN.3" DEPTH, SHREDDED BARK NATURAL BROWN LANDSCAPE MULCH OVER SPECIFIED GEOTEXTILE WEED CONTROL FABRIC . ALL GROUND COVER AND PERENNIAL FLOWER BEDS SHALL BE MULCHED WITH 3" DEPTH SHREDDED BARK NATURAL BROWN LANDSCAPE MULCH. NO WEED CONTROL FABRIC IS REQUIRED IN GROUNDCOVER OR PERENNIAL AREAS.
- 19. AT SEED AREA BOUNDARIES ADJACENT TO EXISTING NATIVE AREAS, OVERLAP ABUTTING NATIVE AREAS BY THE FULL WIDTH OF THE SEEDER.
- 20. EXISTING TURF AREAS THAT ARE DISTURBED DURING CONSTRUCTION, ESTABLISHMENT AND THE MAINTENANCE PERIOD SHALL BE RESTORED WITH NEW SOD TO MATCH EXISTING TURF SPECIES. DISTURBED NATIVE AREAS WHICH ARE TO REMAIN SHALL BE OVER SEEDED AND RESTORED WITH SPECIFIED SEED MIX
- 21. CONTRACTOR SHALL OVER SEED ALL MAINTENANCE OR SERVICE ACCESS BENCHES AND ROADS WITH SPECIFIED SEED MIX UNLESS OTHERWISE NOTED ON THE PLANS.
- 22. ALL SEEDED SLOPES EXCEEDING 25% IN GRADE (4:1) SHALL RECEIVE EROSION CONTROL BLANKETS. PRIOR TO INSTALLATION, NOTIFY OWNER'S REPRESENTATIVE FOR APPROVAL OF LOCATION AND ANY ADDITIONAL COST IF A CHANGE ORDER IS NECESSARY.
- 23. WHEN COMPLETE, ALL GRADES SHALL BE WITHIN +/- 1/8" OF FINISHED GRADES AS SHOWN ON THE PLANS.
- 24. WHEN PLANTER URNS ARE SHOWN ON PLANS, CONTRACTOR SHALL INCLUDE THE FOLLOWING: PLANTER MIX. ANNUAL FLOWER PLANTING PROGRAM (INCLUDES 2 PLANTINGS FOR THE 1ST YEAR (SPRING AND FALL). UNLESS OTHERWISE SPECIFIED CONTRACTOR TO PROVIDE ANNUAL PLANTING SELECTION FOR REVIEW BY OWNER. IRRIGATION FOR PLANTERS TO BE ON SEPARATE ZONE(S), CONTRACTOR TO COORDINATE PLACEMENT OF NECESSARY SLEEVING PRIOR TO PLACEMENT OF PAVEMENT
- PRIOR TO THE PLACEMENT OF MULCH AND WEED FABRIC, A GRANULAR, PRE-EMERGENT WEED CONTROL AGENT SHALL BE ADDED TO ALL PLANTING BEDS IN ACCORDANCE WITH THE MANUFACTURER'S INSTRUCTION, EXCEPT AROUND ORNAMENTAL GRASSES.
- 26. THE CONTRACTOR IS EXPECTED TO KNOW AND UNDERSTAND THE TOWN AND COUNTY SPECIFICATIONS FOR LANDSCAPE AND IRRIGATION. IN CASES OF DISCREPANCIES THE HIGHER OF THE TWO STANDARDS SHALL HAVE PRECEDENCE.
- 27. THE DEVELOPER, HIS SUCCESSORS AND ASSIGNS SHALL BE RESPONSIBLE FOR THE INSTALLATION, MAINTENANCE AND REPLACEMENT OF ALL IMPROVEMENTS SHOWN OR INDICATED ON THE APPROVED LANDSCAPE PLAN ON FILE IN THE PLANNING DEPARTMENT.

LOT COVERAGE

<u> </u>	
LOT AREA:	42,000 SF
BUILDING AREA:	28,219 SF
MIXED USE BUILDING	23,346 SF
FOOTE'S REST:	2,871 SF
HOTEL:	802 SF
STALEY HOUSE:	773 SF
BLACKSMITH SHOP:	427 SF
LANDSCAPE AREA:	
SQUARE FEET:	13,781 SF
PERCENT COVERAGE:	32.8%

EXPOSURE SIZE & COND. WATER **BOTANICAL NAME** SYM. COMMON NAME **DECIDUOUS TREES (30)** QUAKING ASPEN (SINGLE STEM) POPULOUS TREMULOIDES 3" CAL, B&B SUN MED 6-8' HT, B&B, CLUMP, COLLECTED MED ANC QUAKING ASPEN (CLUMP) POPULOUS TREMULOIDES SUN NAR NARROWLEAF COTTONWOOD POPULOUS ANGUSTIFOLIA 3" CAL, B&B SUN LOW-MED SHUBERT CHOKECHERRY SHC PRUNUS VIRGINIANA 'SHUBERT' 3" CAL, B&B SUN/PART LOW-MED SHUBERT CHOKECHERRY PRUNUS VIRGINIANA 'SHUBERT' 2" CAL, B&B SUN/PART LOW-MED NCH NATIVE CHOKECHERRY PRUNUS VIRGINIANA 2" CAL, B&B SUN/PART LOW-MED ROCKY MOUNTAIN GLOW MAPLE ACER GRANDIDENTATUM 'SCHMIDT' 3" CAL, B&B SUN/PART MED JAPANESE TREE LILAC (CLUMP) SYRINGA RETICULATA 6-8' HT, CLUMP SUN XERIC-MED EVERGREEN TREES (8) BRISTLECONE PINE FOX PINUS ARISTATA 10' HT. MIN., B&B, NURSERY GROWN SUN/PART XERIC **BRISTLECONE PINE XERIC** FOX PINUS ARISTATA 8' HT. MIN., B&B, NURSERY GROWN SUN/PART CCF SUN/PART MED WHITE FIR ABIES CONCOLOR 6' HT. MIN., B&B

	2	HOO	HOOPSI SPRUCE	PICEA PUNGENS 'HOOPSII'	6' HT. MIN., B&B	SUN	LOW-MED
(+)+		— EVER	RGREEN SHRUBS (4)				
	4	BRO	BROADMOOR JUNIPER	JUNIPERUS SABINA 'BROADMOOR'	#5 CONT.	SUN/PART	XERIC
		— DECII	DUOUS SHRUBS (14)				
	2	CAC	PEKING COTONEASTER	COTONEASTER LUCIDUS	#5 CONT.	SUN/PART	XERIC
	4	NMO	MOUNTAIN NINEBARK	PHYSOCARPUS MONOGYNUS	#5 CONT.	SUN/PART	LOW-MED
	2	ALS	URAL FALSE SPIREA	SORBARIA SORBIFOLIA	#5 CONT.	SUN/PART	LOW-MED
	2	RWO	WOODS ROSE	ROSA WOODSII	#5 CONT.	SUN/PART	XERIC
	2	RLR	REDLEAF ROSE	ROSA GLAUCA 'RUBRIFOLIA'	#5 CONT.	SUN/PART	XERIC
	2	ART	DWARF ARTIC BLUE WILLOW	SALIX PURPUREA 'NANA'	#5 CONT.	SUN/PART	WET
		— ORNA	AMENTAL GRASSES ———				

DESCHAMPSIA CESPITOSA

ACHNATHERUM HYMENOIDES

LANDSCAPE REQUIREMENTS

PLANTING SCHEDULE

REQUIREMENTS

1 TREE PER 1,500 SF OF DEVELOPMENT AREA (28 TREES) 1 SHRUB PER 2,500 SF OF DEVELOPMENT AREA (17 SHRUBS) BLOCK 11 AREA: 42,000 SF

LAWN AREA: 1,016 SF (7.3% OF UNDEVELOPED AREA OF THE SITE)

BREAK DOWN	REQ.	PROVIDED	EXISTING	TOTAL
TREES	28	38	2	40
DECIDUOUS	18	30	0	30
3" CAL	9	9	0	9
2" CAL	9	18	0	18
BY HEIGHT	N/A	11	0	11
EVERGREEN	10	8	2	10
10' HT.	3	2	2	4
8' HT.	3	3	0	3
6' HT.	4	4	0	4
SHRUBS	17	18	0	18
DECIDUOUS	N/A	4	0	4
EVERGREEN	N/A	14	0	14

TUFTED HAIR GRASS

INDIAN RICE GRASS

* ADDITIONAL TREES ARE PLANTED SMALLER THAN REQUIRED. IT IS STRONGLY BELIEVED THAT THIS IS BETTER FOR THE SITE AND THE HEALTH OF THE PLANTINGS

SUN TOLERANT PERENNIALS (ROOF

#1 CONT.

#1 CONT.

	COMMON NAME	BOTANICAL NAME		
BPL RGD	BELL FLOWER BLACK-EYED SUSAN	CAMPANULA PERSICIFOLIA RUDBECKIA FULGIDA 'GOLDSTRUM'		
DSD CFL	DWARF SHASTA DAISY CONE FLOWER SP.	LEUCANTHEMUM COMPACT 'SNOW LADY' ECHINACEA SP.		
APF	EUROPEAN PASQUE FLOWER	PULSATILLA VULGARIS		
PHR SMN	HUSKER RED PENSTEMON MAY NIGHT SALVIA	PENSTEMON PINIFOLIUS 'HUSKER RED' SALVIA SYLVESTRIS X 'MAINACHT'		
SES CMW	AUTUMN JOY SEDUM WALKER'S LOW CATMINT	SEDUM 'AUTUMN JOY' NEPETA FAASSENII 'WALKER'S LOW'		

SUN

MED

XERIC


SHAD	DE TOLERANT PERENNIALS	
	COMMON NAME	BOTANICAL NAME
BBA	BEE BALM	MONARDA DIDYMA
SOM	BISHOP'S WEED	AEGOPODIUM PODOGRARIA 'VARIEGATUM'
CLR	COLUMBINE SP.	AQUILEGIA SP.
LAE	EDELWEISS	LEONTOPODIUM ALPINUM
APF	EUROPEAN PASQUE FLOWER	PULSATILLA VULGARIS
FJF	FALSE FORGET-ME-NOT	BRUNNERA MACROPHYLLA 'JACK FROST'
IRG	GERMAN BEARDED IRIS	IRIS GERMANICA VAR.
PAN	PANSY SP.	VIOLA SP.
LPD	PURPLE DRAGON NETTLE	LAMIUM MACULATUM 'PURPLE DRAGON'
WIN	WINDFLOWER	ANEMONE SYLVESTRIS

TURF GRASS

COMMON NAME

ECOLOTURF (OR APPROVED EQUAL)

LANDSCAPE DETAILS

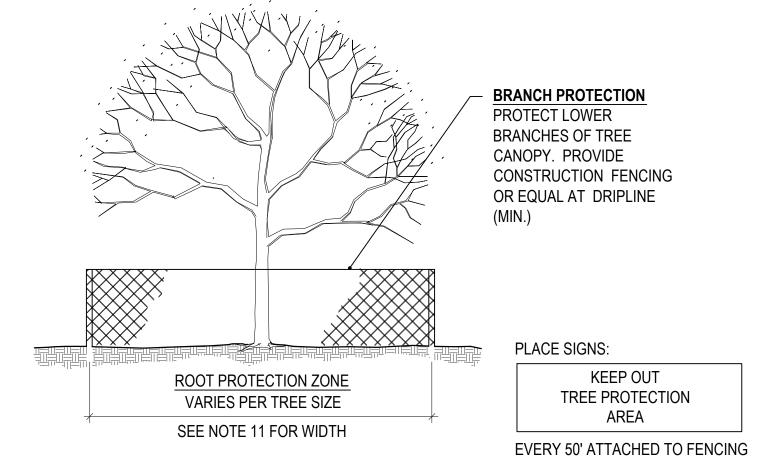

TREE PROTECTION NOTES

- I. ALL TREES AND SHRUBS TO BE PROTECTED AND PRESERVED SHALL BE PER DETAIL. GROUPING OF MORE THAN ONE TREE MAY OCCUR.
- 2. TREES AND SHRUBS TO BE PROTECTED AND PRESERVED SHALL BE IDENTIFIED ON THE TRUNK WITH SURVEY TAPE.
- 3. TO PREVENT ROOT SMOTHERING, SOIL STOCKPILES, SUPPLIES, EQUIPMENT OR ANY OTHER MATERIAL SHALL NOT BE PLACED OR STORED WITHIN THE DRIP
- LINE OR WITHIN 15 FEET OF A TREE OR SHRUB TRUNK, WHICHEVER IS GREATER.
- 4. TREE AND SHRUB ROOTS SHALL NOT BE CUT UNLESS CUTTING IS UNAVOIDABLE.
- 5. TRENCHES SHALL BE HAND DUG WITHIN THE DRIP LINE IN AREAS WHERE ROOTS TWO INCHES IN DIAMETER AND GREATER ARE PRESENT, OR WHEN IN CLOSE PROXIMITY TO LOW BRANCHING TREES. WHENEVER POSSIBLE, ROOTS TWO INCHES OR GREATER IN DIAMETER SHALL BE TUNNELED OR BORED UNDER AND SHALL BE COVERED TO PREVENT DEHYDRATION.
- 6. WHEN ROOT CUTTING IS UNAVOIDABLE, A CLEAN SHARP CUT SHALL BE MADE TO AVOID SHREDDING OR SMASHING. ROOT CUTS SHOULD BE MADE BACK TO A LATERAL ROOT. WHENEVER POSSIBLE, ROOTS SHOULD BE CUT BETWEEN LATE FALL AND BUD OPENING, WHEN ROOT ENERGY SUPPLIES ARE HIGH AND CONDITIONS ARE LEAST FAVORABLE FOR DISEASE CAUSING AGENTS. EXPOSED ROOTS SHALL BE COVERED IMMEDIATELY TO PREVENT DEHYDRATION. ROOTS SHALL BE COVERED WITH SOIL OR BURLAP AND KEPT MOIST.
- WATERING OF PROTECTED TREES IN WHICH ROOTS WERE CUT SHALL BE PROVIDED BY THE CONTRACTOR.
- 8. AUGER TUNNELING RATHER THAN TRENCHING SHOULD BE USED FOR UTILITY PLACEMENT WITHIN DRIP LINE.
- 9. FENCING MATERIAL SHALL ENCIRCLE ANY TREE OR SHRUB WHOSE OUTER DRIP LINE EDGE IS WITHIN 20 FEET OF ANY CONSTRUCTION ACTIVITIES.
- 10. FENCING MATERIAL SHALL BE BRIGHT, CONTRASTING COLOR, DURABLE, AND A MINIMUM OF FOUR FEET IN HEIGHT.
- 11. FENCING MATERIAL SHALL BE SET AT THE DRIP LINE OR 15 FEET FROM TREE TRUNK, WHICHEVER IS GREATER, AND MAINTAINED IN AN UPRIGHT POSITION THROUGHOUT THE DURATION OF CONSTRUCTION ACTIVITIES.
- 12. ANY GRADE CHANGES (SUCH AS THE REMOVAL OF TOPSOIL OR ADDITION OF FILL MATERIAL) WITHIN THE DRIP LINE SHOULD BE AVOIDED FOR EXISTING TREES TO REMAIN. RETAINING WALLS AND TREE WELLS ARE ACCEPTABLE ONLY WHEN CONSTRUCTED PRIOR TO GRADE CHANGE.

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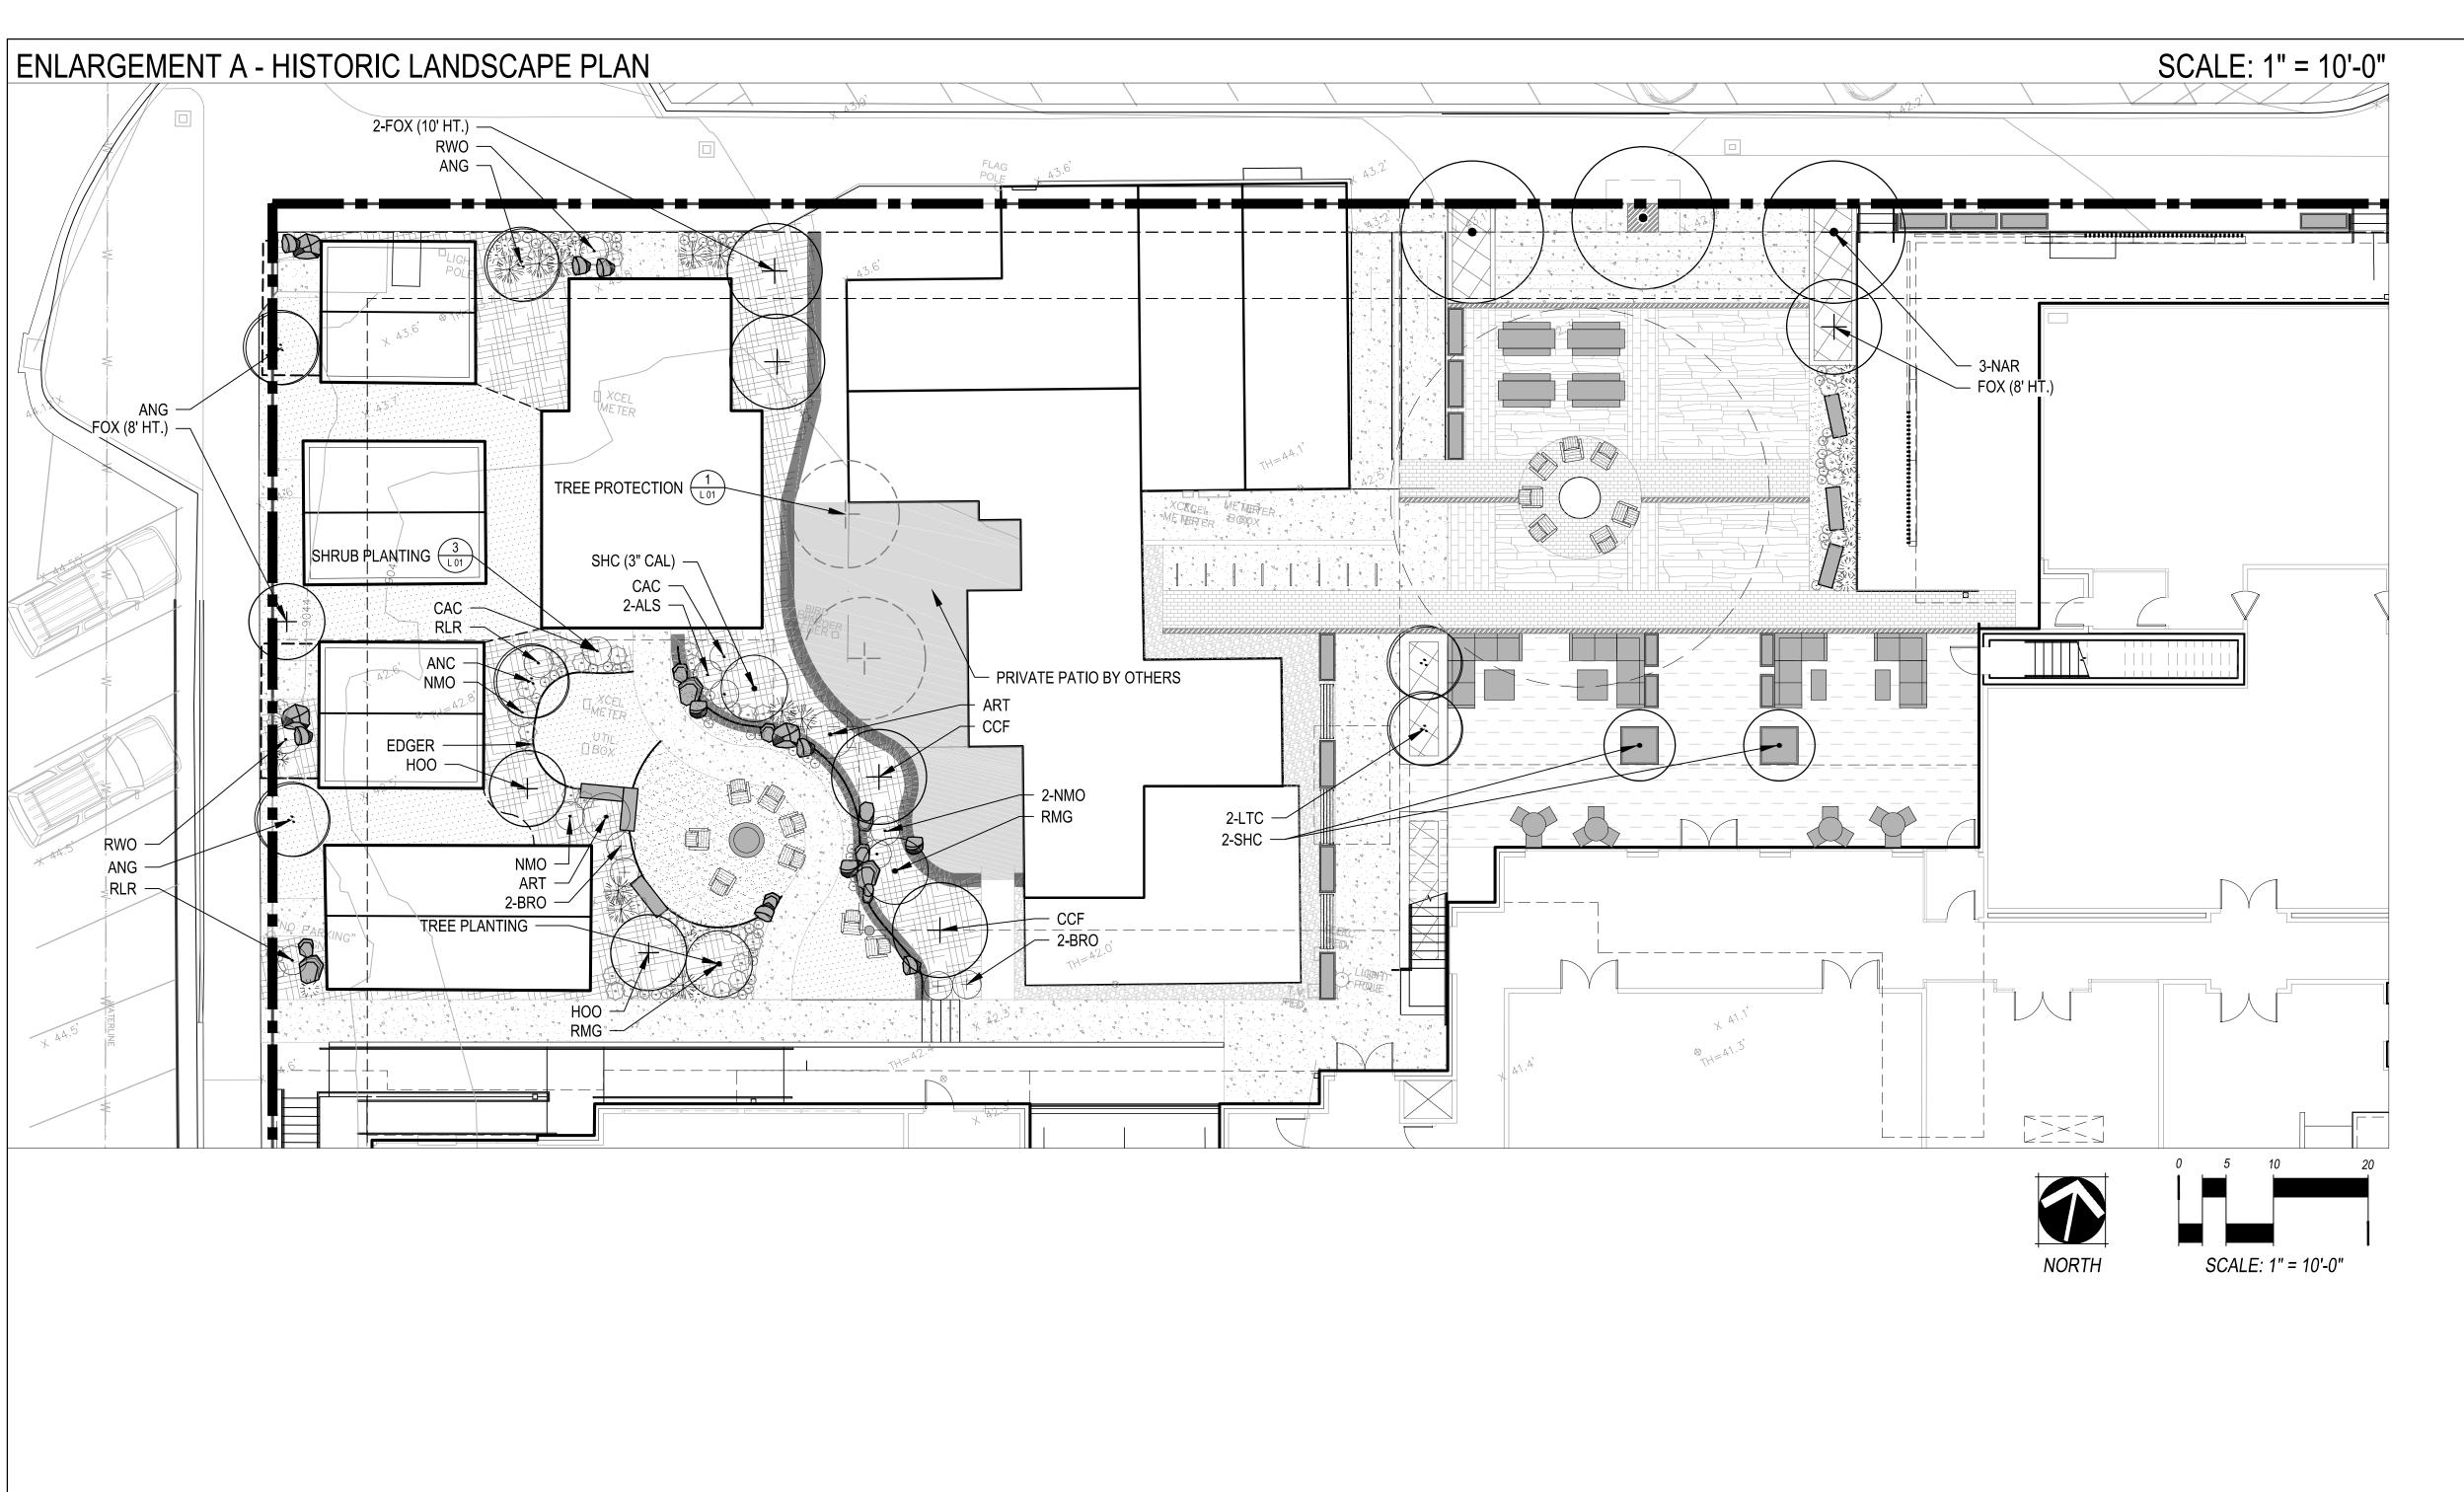
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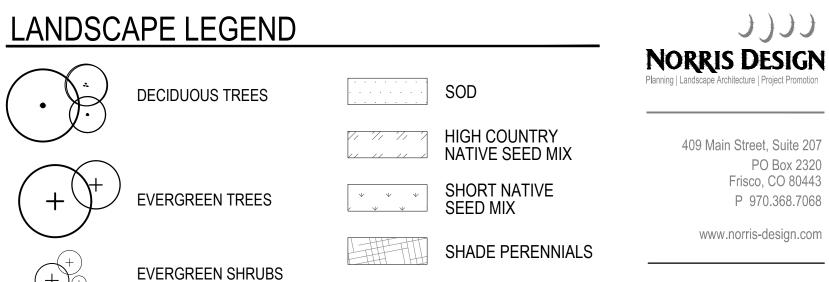
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SHEET TITLE: **CLANDSCAPE NOTES** & SCHEDULE

L-002

TREE AND SHRUB PROTECTION





SHADE PERENNIALS DECIDUOUS SHRUBS SUN PERENNIALS ORNAMENTAL GRASSES MTN WILDFLOWER MIX

COBBLE DRIP EDGER PERENNIALS D.G. EXISTING TREE TO CONCRETE

PAVER TYPE 1 PAVER TYPE 2 ————— EDGER-SPADE

STACKED STONE WALL ■■■ PROPERTY LINE & LIMIT OF WORK

PAVER TYPE 3 PAVER TYPE 4

NOTES

- 1. REFERENCE ENGINEER AND SURVEYOR PLANS FOR RESPECTIVE UTILITIES, GRADING AND DRAINAGE.
- 2. RESEED ALL AREAS WITH SPECIFIED SEED MIX UNLESS OTHERWISE DESIGNATED. 3. THESE PLANS SHALL NOT BE UTILIZED FOR CONSTRUCTION OR PERMITTING
- UNLESS STATED FOR SUCH USE IN THE TITLE BLOCK. 4. PLANT SYMBOLS ARE SHOWN AT APPROXIMATELY MATURE SIZE.
- 5. ALL PLANTINGS SHALL BE PLANTED TO AVOID CONFLICTS WITH SIGHT TRIANGLES AND EXISTING AND PROPOSED UTILITIES. NOTIFY LANDSCAPE ARCHITECT OF CONFLICTS.
- 6. FINAL PLANT LOCATIONS SHALL BE FIELD VERIFIED.
- 7. PRESERVE AND PROTECT EXISTING TREES AS POSSIBLE. TREE PROTECTION DETAIL AND NOTES PROVIDED.
- 8. FINAL IRRIGATION DESIGN BY OTHERS. IRRIGATION DESIGN TO BE COORDINATED WITH ENGINEERS AND ARCHITECTS FOR PROPER IRRIGATION RATES.
- 8.1. GROUND LEVEL - ALL TREES AND SHRUBS TO BE IRRIGATED WITH DRIP IRRIGATION
- ALL TURF, NATIVE GRASS, PERENNIALS AND/ OR ANNUAL BEDS TO BE
- SPRAY IRRIGATED / INLINE DRIP IRRIGATION. 8.2. 2ND FLOOR AND ROOF TOP

- ALL PLANTERS AND BEDS TO BE IRRIGATED WITH NETAFIM DRIP IRRIGATION OR APPROVED EQUAL.

1)))) NORRIS DESIGN

OWNER:

512 MAIN STREET, LLC.

PO BOX 307

FRSICO, CO 80443


970.389.2660

DATE: 05.15.17: SK PLN 01 06.28.17: SK PLN 02 09.06.17: DA 01 09.30.17: DA PRICING 11.03.17: DA 02

SHEET TITLE: C LANDSCAPE PLAN **LL** ENLARGEMENTS

L-200

CHECKED BY: DRAWN BY:

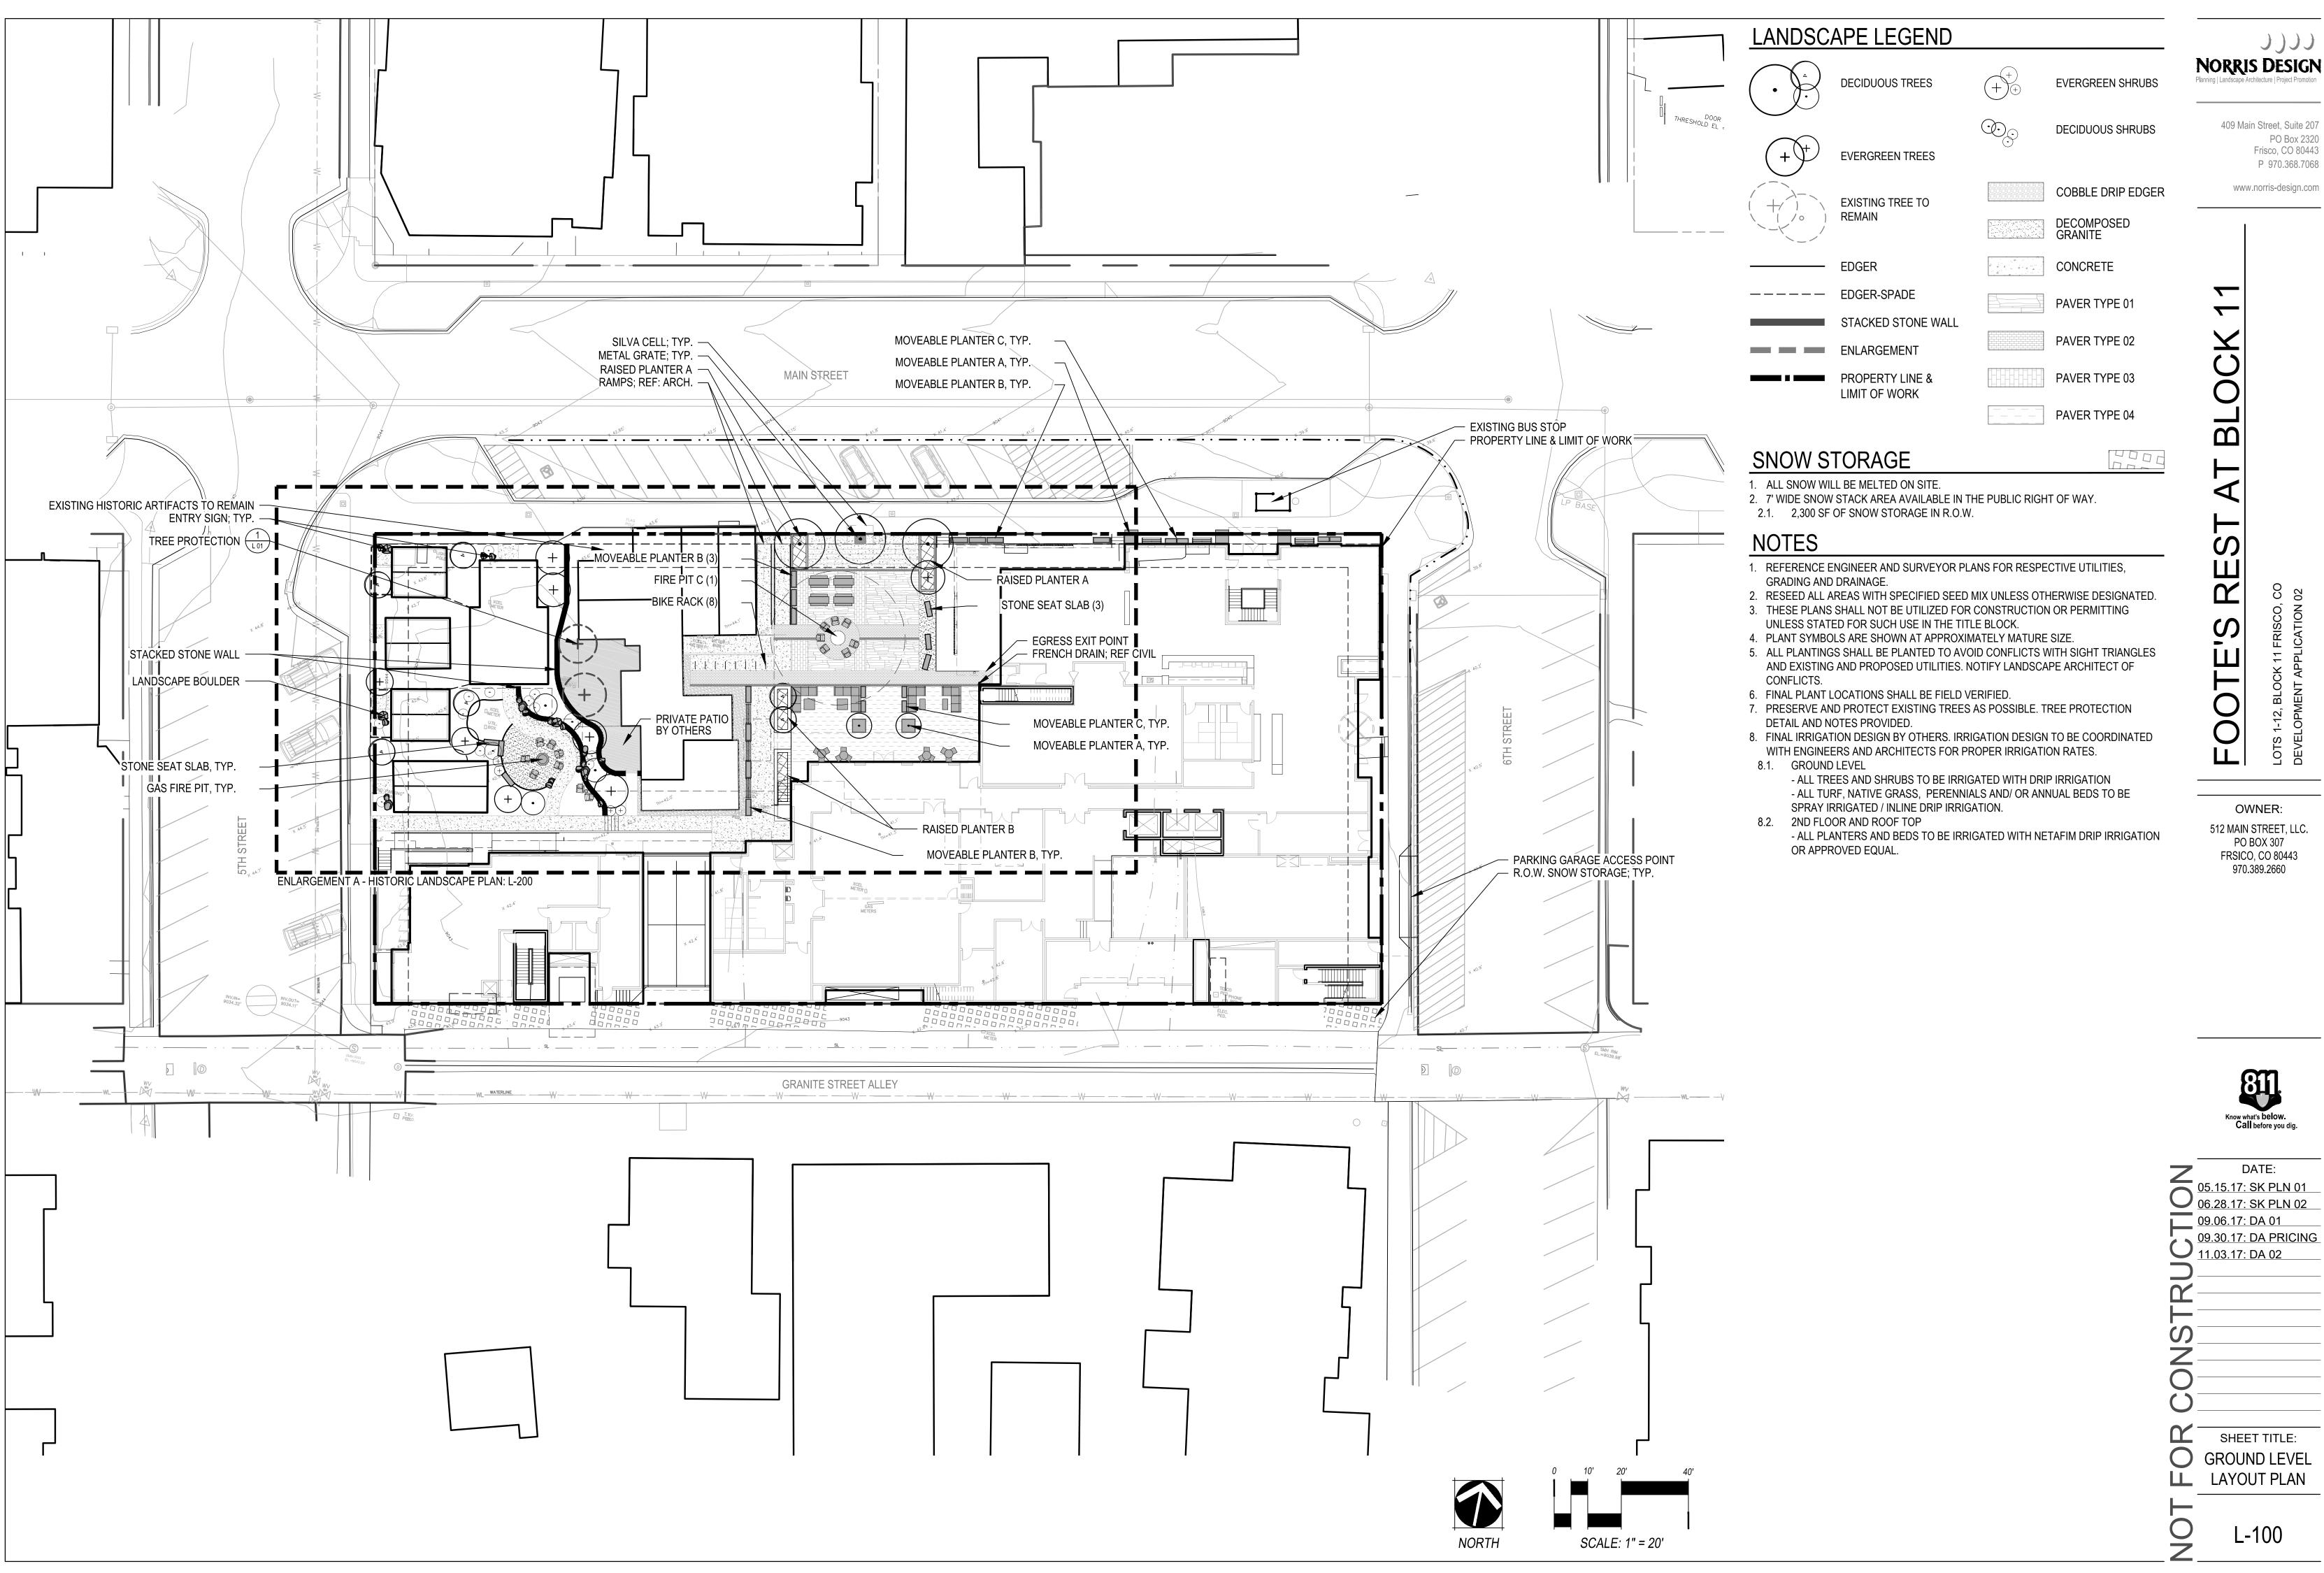

CHECKED BY: DRAWN BY:

1)))) NORRIS DESIGN

> 409 Main Street, Suite 207 PO Box 2320 Frisco, CO 80443

www.norris-design.com


OWNER:

PO BOX 307 FRSICO, CO 80443 970.389.2660



05.15.17: SK PLN 01 06.28.17: SK PLN 02 09.30.17: DA PRICING

GROUND LEVEL LAYOUT PLAN

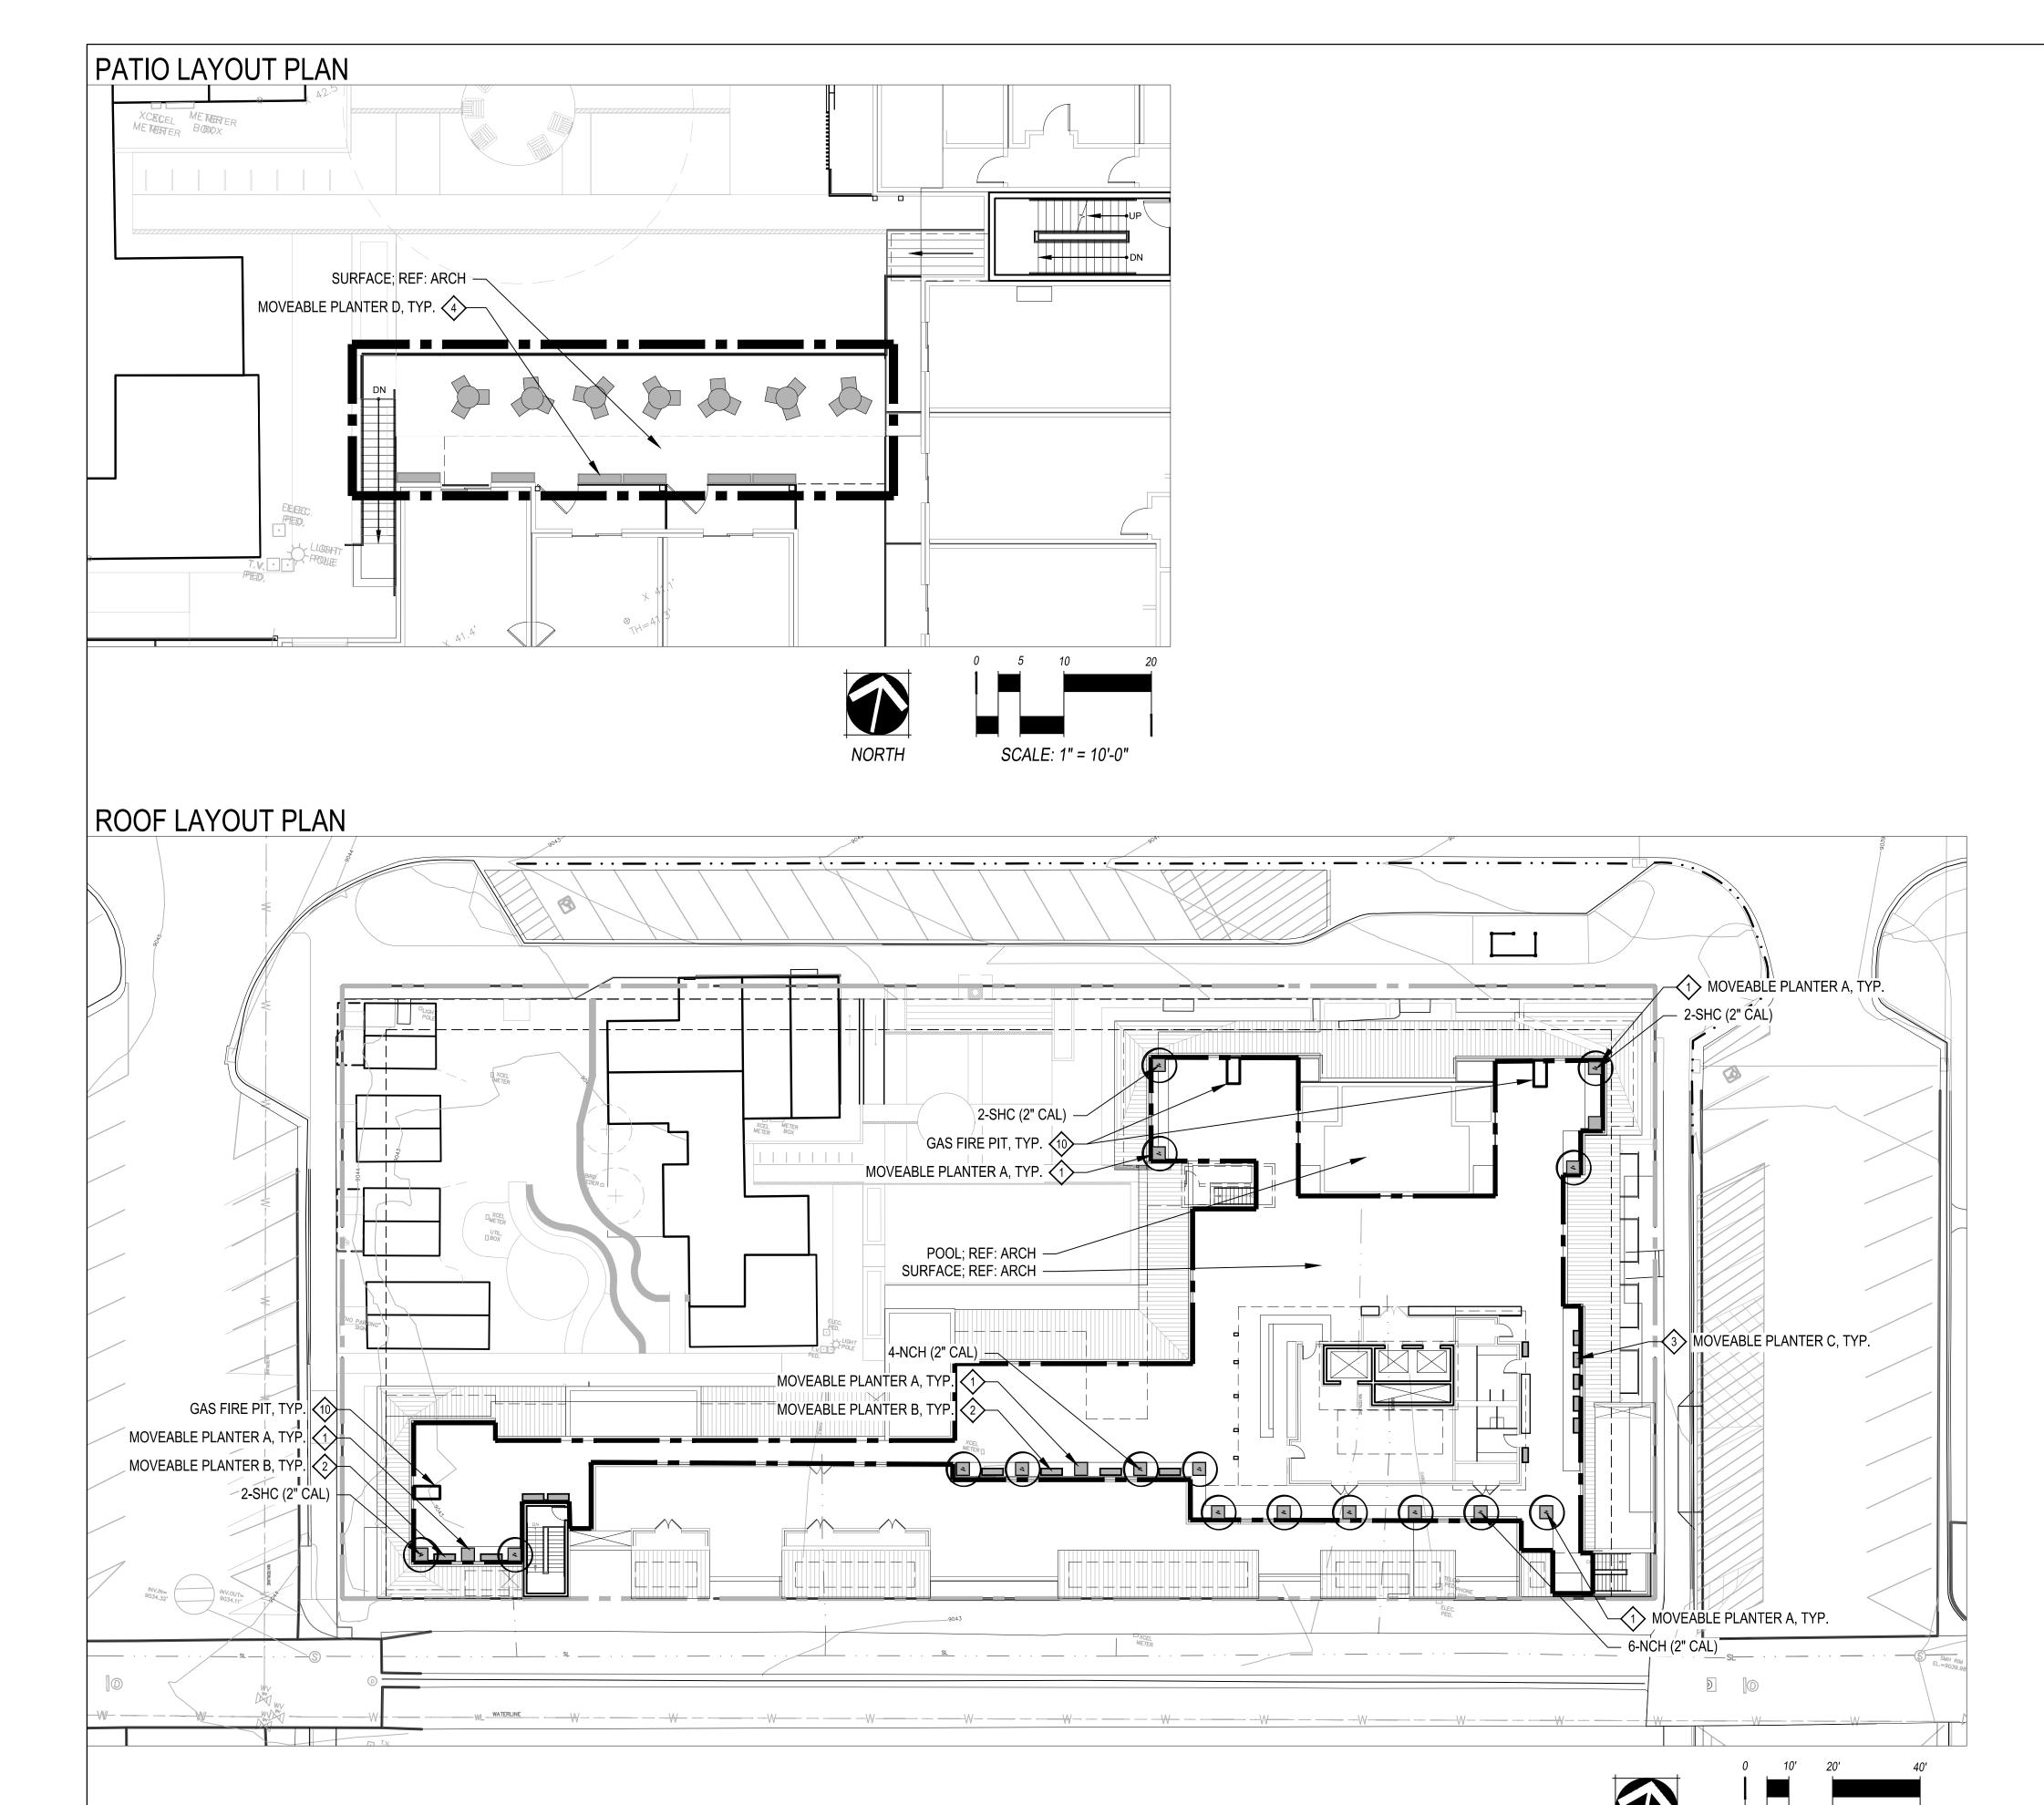

LANDSCAPE LEGEND

DECIDUOUS TREES

ENLARGEMENT

■ ■ ■ LIMIT OF WORK

NOTES

SCALE: 1" = 20'

- 1. REFERENCE ENGINEER AND SURVEYOR PLANS FOR RESPECTIVE UTILITIES, GRADING AND DRAINAGE.
- 2. RESEED ALL AREAS WITH SPECIFIED SEED MIX UNLESS OTHERWISE DESIGNATED. 3. THESE PLANS SHALL NOT BE UTILIZED FOR CONSTRUCTION OR PERMITTING
- UNLESS STATED FOR SUCH USE IN THE TITLE BLOCK.
- 4. PLANT SYMBOLS ARE SHOWN AT APPROXIMATELY MATURE SIZE.
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- 8.2. 2ND FLOOR AND ROOF TOP
 - ALL PLANTERS AND BEDS TO BE IRRIGATED WITH NETAFIM DRIP IRRIGATION OR APPROVED EQUAL.

1)))) NORRIS DESIGN

409 Main Street, Suite 207

PO Box 2320 Frisco, CO 80443

P 970.368.7068

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SHEET TITLE:

C LANDSCAPE PLAN ■ ENLARGEMENTS

L-201









<u>SCREENS</u>





FIRE FEATURES







LIGHTING











PLANTERS













MATERIALS















NORRIS DESIGN
Planning | Landscape Architecture | Project Promotion

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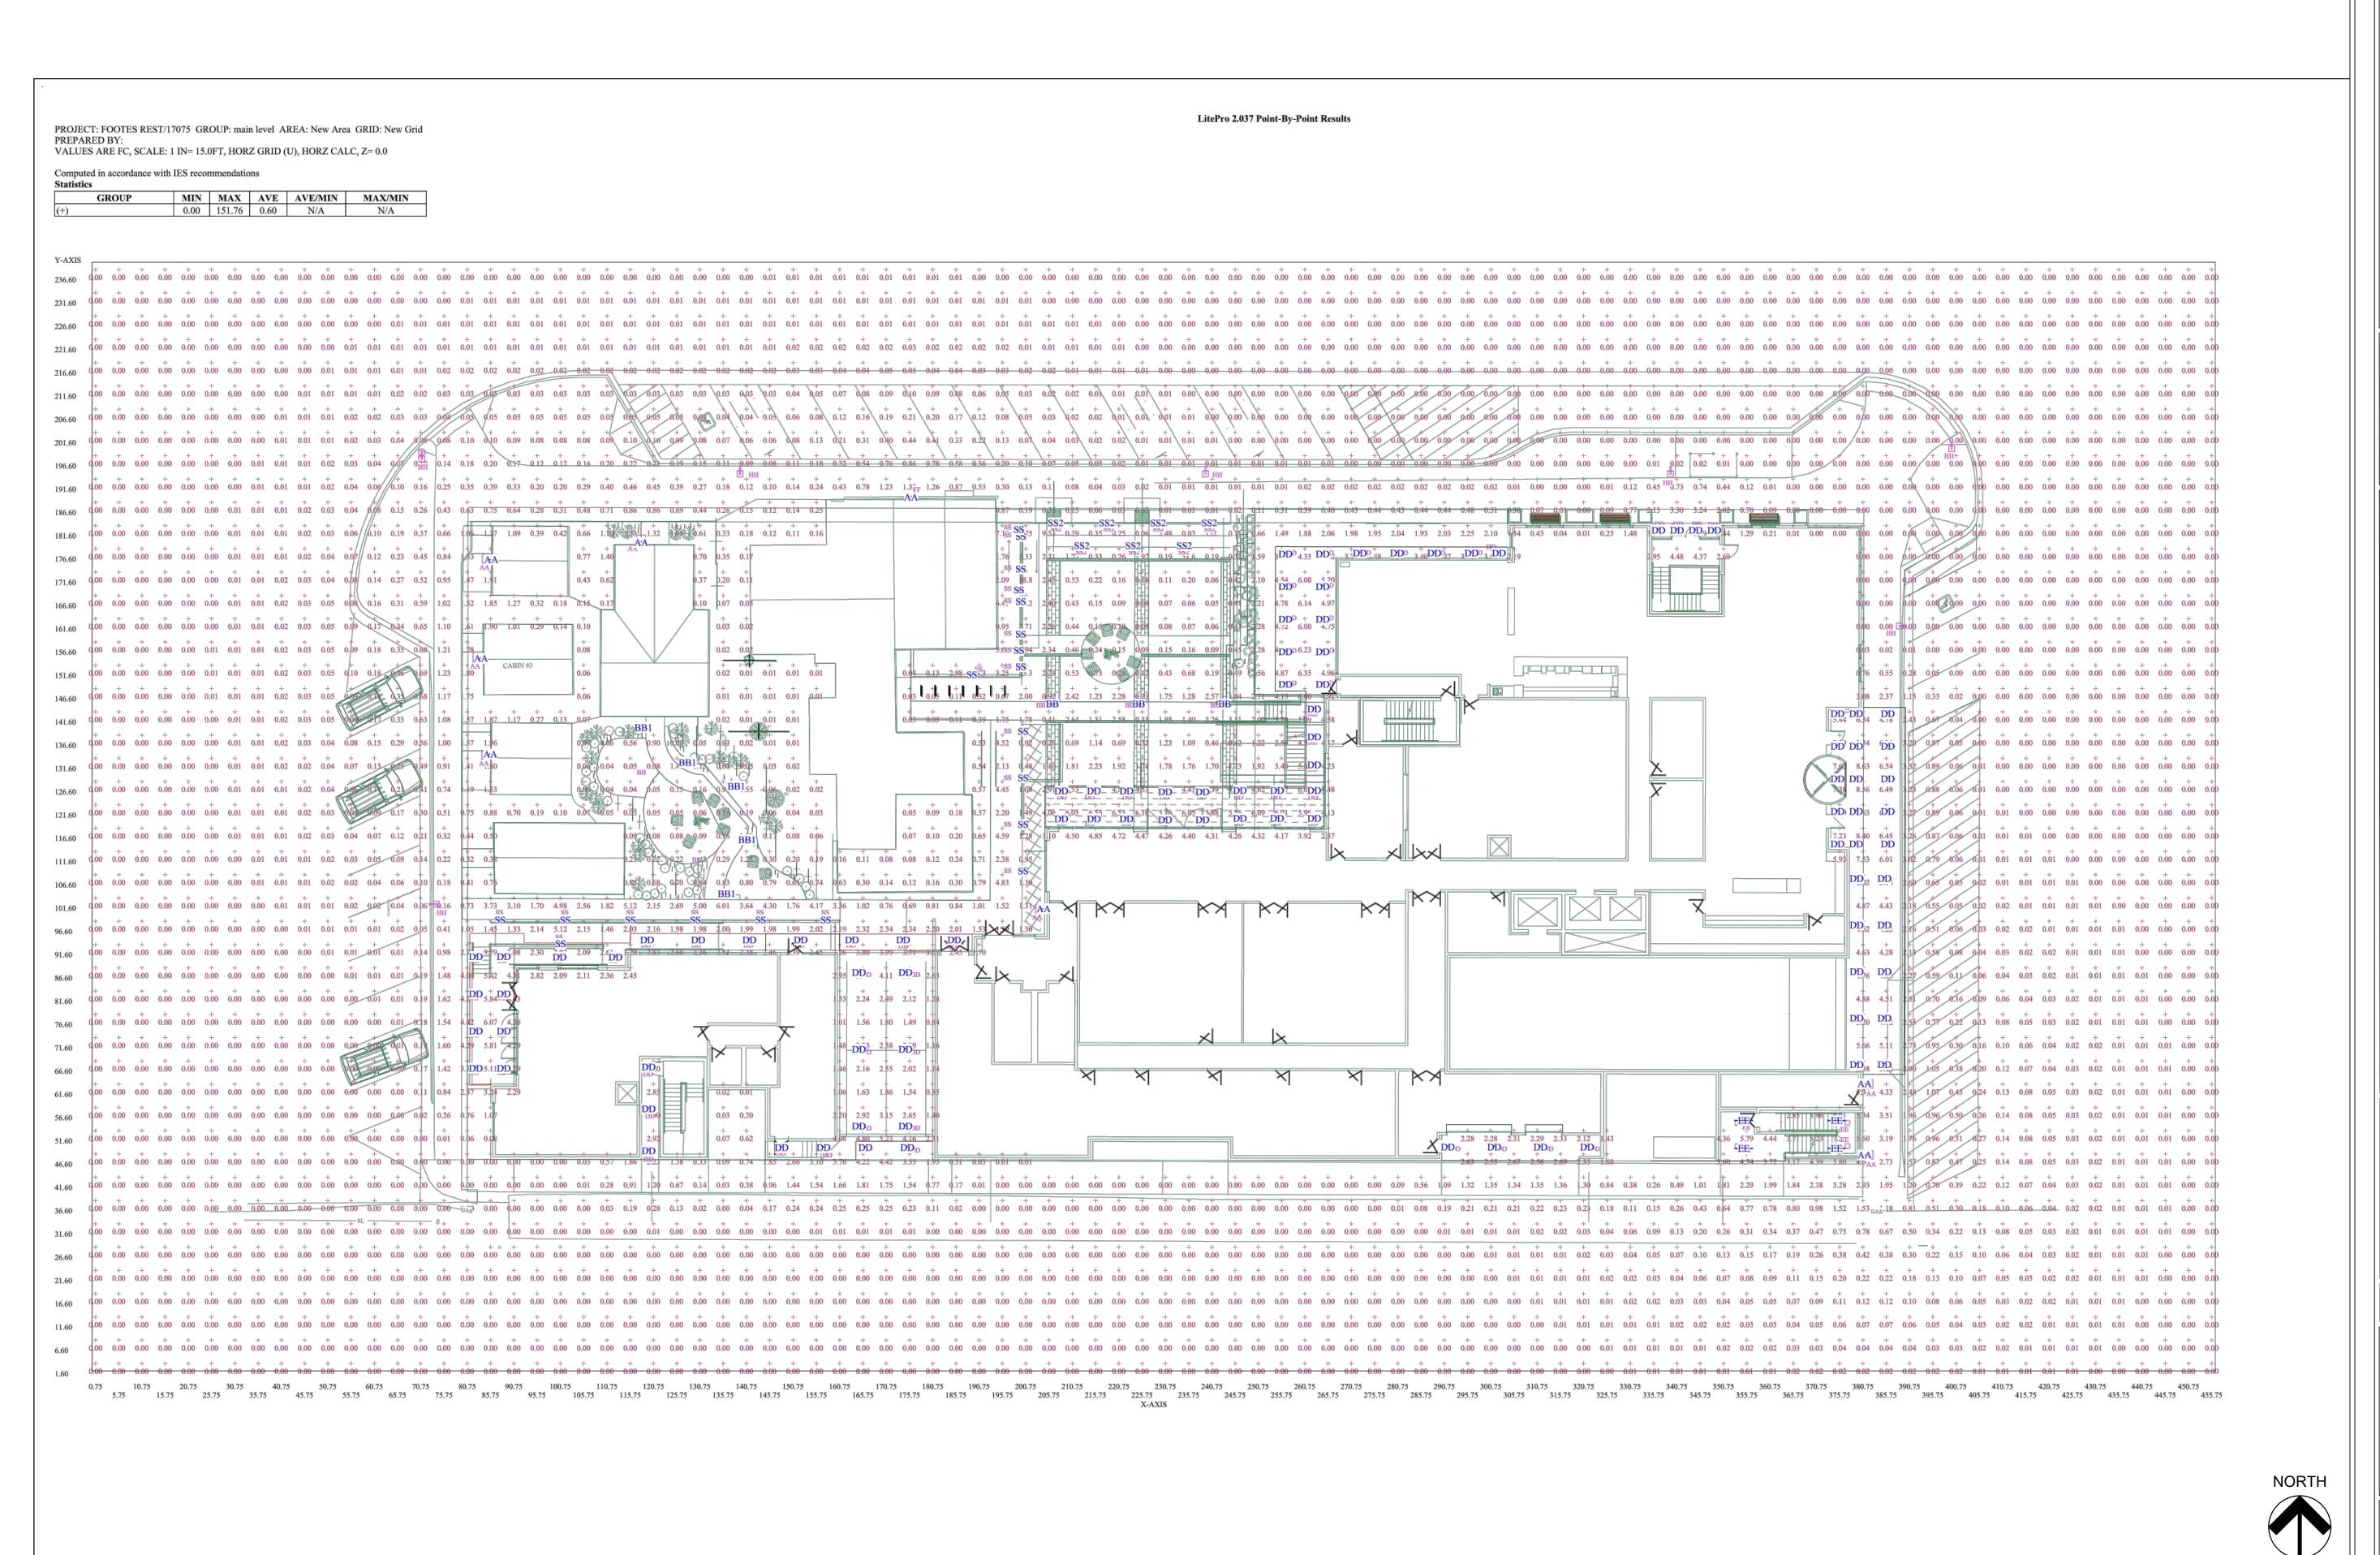
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CHARACTER

L-400



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BLOCK 11 500 MAIN STREET

AEC PROJECT #: 17075

DATE: ISSUE:

09-06-17 PLANNING SUBMITTAL

9-00-17 PLANNING SUBIVITTA


SOH Checked By:
AEC

PROPOSED LEVEL ONE PT TO PT FCS

> PLAN 1/16"=1'-0"

E3.1

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500 MAIN STREET

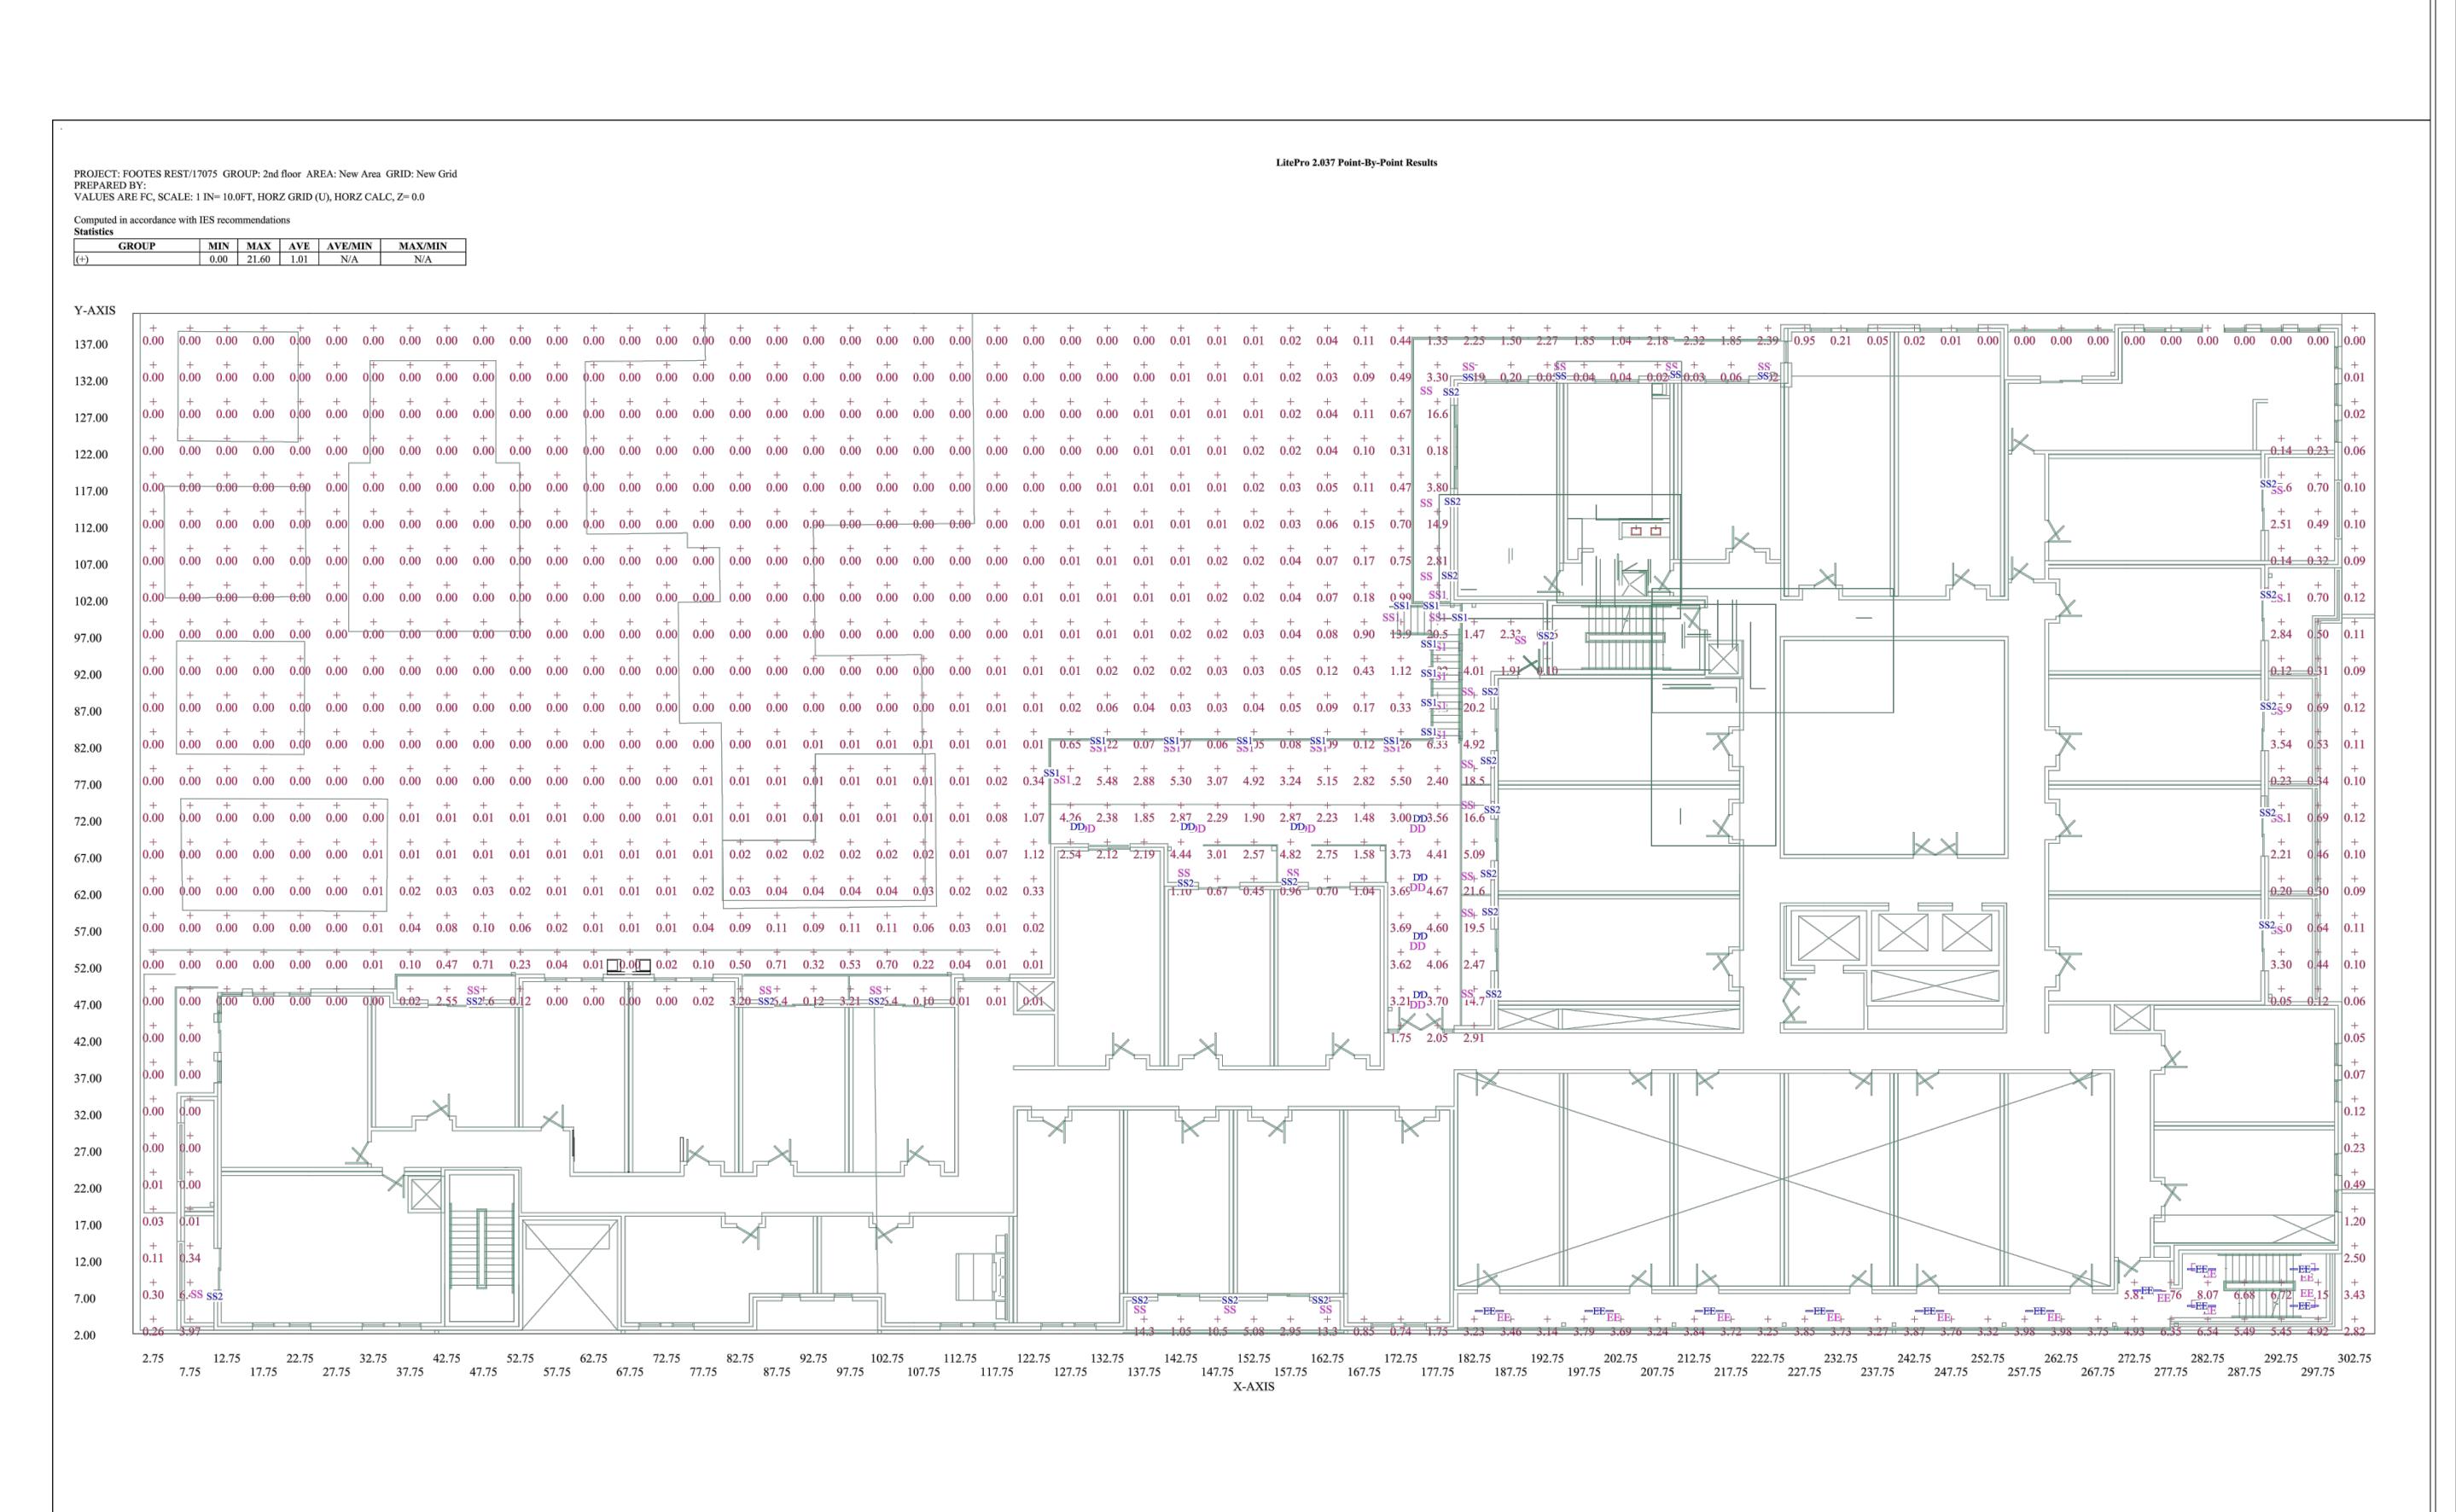AEC PROJECT #: 17075				
DATE:	ISSUE			
09-06-17	7 PLANNING SUBMITTAL			
Drawn By:		Checked By:		
SOH		AEC		

PROPOSED LEVEL TWO PT TO PT FCS

> PLAN 1/16"=1'-0"

LitePro 2.037 Point-By-Point Results PROJECT: FOOTES REST/17075 GROUP: 3rd floor AREA: 3RD FLOOR GRID: New Grid VALUES ARE FC, SCALE: 1 IN= 10.0FT, HORZ GRID (U), HORZ CALC, Z= 0.0 Computed in accordance with IES recommendations MIN MAX AVE AVE/MIN MAX/MIN 0.00 16.90 0.48 N/A N/A $0.00 \quad 0.00 \quad$ 0.00 0.08S 2.59 0.24 0.07 0.00 | 1.77 | 0.28 | 0.09 | $0.00 \quad 0.00 \quad$ GNSS 3.52 0.32 0.10 $0.\phi0 \quad | 0.00 \quad 0.00 \quad 0.00 \quad | 0.00 \quad | 0.00 \quad 0$ 0.02 2.25 0.33 0.10 0 4 1 0.33 0.10 $0.00 \quad | 0.00 \quad 0.00 \quad 0.00 \quad | 0.00 \quad | 0.00 \quad 0$ $0.\phi 0 \quad | 0.00 \quad 0.00 \quad 0.00 \quad | 0.00 \quad 0.00 \quad | 0.00 \quad 0.00 \quad$ 1.85 1.68 0.24 0.08 0.00 2.70 0.35 0.13 0.06 0.00 0.66 0.19 0.08 0.04 0.00 2.06 0.23 0.07 0.04 $0.\phi0$ $0.\phi0$ 0.00 0 00 | 3.18 | 0.25 | 0.07 | 0.03 0.00 0.69 0.18 0.07 0.03 $0.\phi0 \quad 0.00 \quad 0.01 \quad$ $0.00 + 1.93 \mid 0.23 \quad 0.07 \quad 0.03$ 0.00 0.00 0.00 0.00 0.00 0.00 0.00 0.00 0.00 0.01 0 00 | 3.29 | 0.26 | 0.08 | 0.04 | 9 44 SS 2 6.65 0.21 9 10 SS 2 8.22 0.14 0.14 $0.\phi0 \quad 0.00 \quad 0.00 \quad 0.00 \quad 0.00 \quad 0.01 \quad \phi.01 \quad 0.02 \quad 0.02 \quad \phi.\phi2 \quad | \ 0.01 \quad 0.01 \quad 0.01 \quad 0.01 \quad 0.02 \quad 0.02 \quad 0.03 \quad 0.04 \quad 0.04 \quad 0.03 \quad 0.03 \quad \phi.02 \quad 0.01 \quad 0.0$ 0.01 0.76 0.20 0.07 0.04 0.01 2.31 0.25 0.08 0.04 $0.00 \quad 0.00 \quad 0.00 \quad 0.00 \quad 0.00 \quad 0.00 \quad 0.01 \quad 0.02 \quad 0.05 \quad 0.07 \quad 0.06 \quad 0.03 \quad 0.01 \quad 0.01 \quad 0.03 \quad 0.06 \quad 0.09 \quad 0.09 \quad 0.09 \quad 0.09 \quad 0.07 \quad 0.03 \quad 0.01 \quad 0.01 \quad 0.00 \quad$ 0 15 5.18 4. SS (SS2) 0.01 0.04 0.16 0.31 0.22 0.07 0.02 0.01 0.01 0.06 0.21 0.42 0.33 0.33 0.46 0.25 0.07 0.02 0.01 0.00 3.65 0.26 0.07 0.03 0.13 0.06 0.03 0.00 0.00 0.00 0.00 0.00 0.06 0.04 0.03 51.45 0.06 0.05 0.04 46.45 0.09 0.07 0.06 0.18 0.13 0.09 36.45 0.37 0.25 0.16 31.45 0.88 0.53 0.30 26.45 **2.**12 1.06 0.50 21.45 16.45 57.50 67.50 77.50 87.50 97.50 107.50 127.50 127.50 137.50 147.50 157.50 167.50 197.50 207.50 227.50 227.50 237.50 247.50 257.50 267.50 267.50 297.50 297.50 307.50 X-AXIS

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BLOCK 11 500 MAIN STREET

AEC PR	OJECT #: 17075
DATE:	ISSUE:
09-06-17	PLANNING SUBMITTAL

PROPOSED
LEVEL THREE
PT TO PT FCS


PLAN
1/16"=1'-0"

LitePro 2.037 Point-By-Point Results

PROJECT: FOOTES REST/17075 GROUP: ROOF AREA: New Area GRID: New Grid PREPARED BY: VALUES ARE FC, SCALE: 1 IN= 10.0FT, HORZ GRID (U), HORZ CALC, Z= 0.0

Computed in accordance with IES recommendations

GROUP	MIN	MAX	AVE	AVE/MIN	MAX/MIN
+)	0.00	16.24	1.29	N/A	N/A

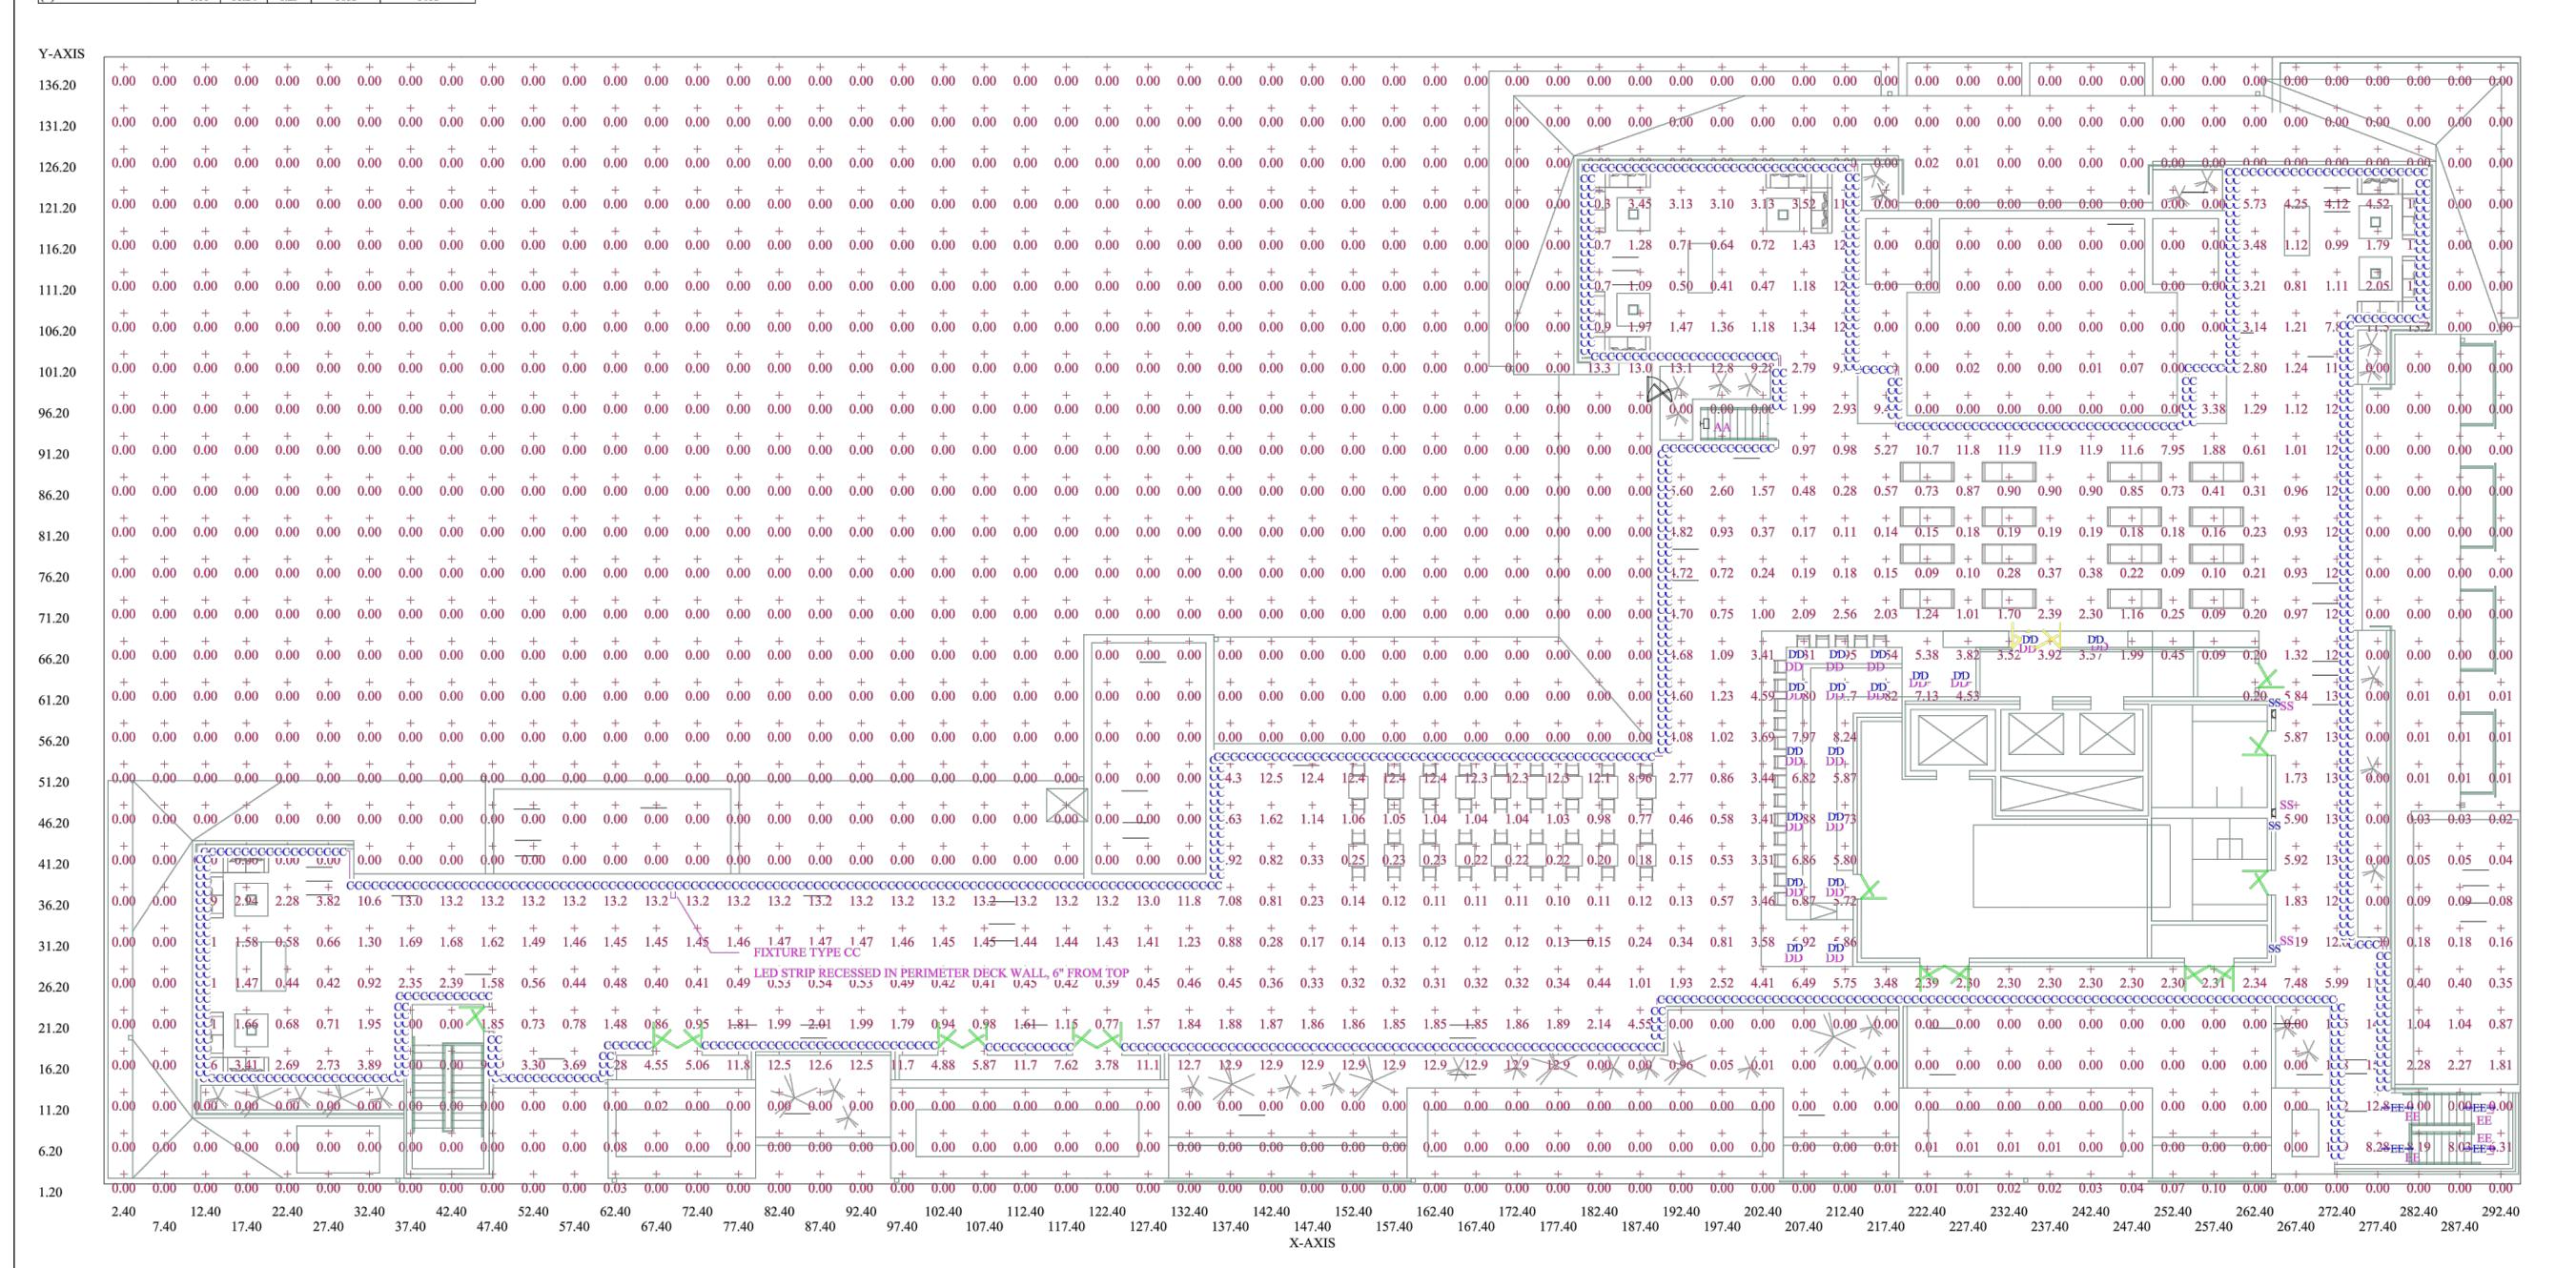

NORTH

FOOTES REST BLOCK 11 500 MAIN STREET

	AEC PR	17075	
	DATE:	ISSUE:	
	09-06-17	PLANNING	SUBMITTA
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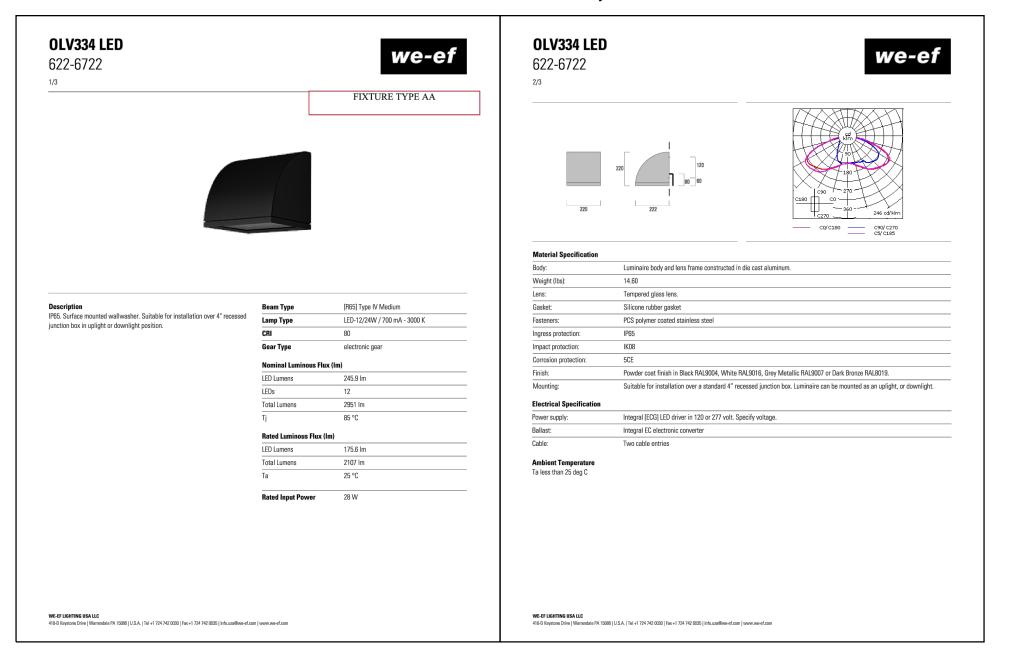
awn By: Checked By:


SOH AEG

PROPOSED LEVEL ROOF PT TO PT FCS

PLAN
1/16"=1'-0"


FIXTURE TYPE AA, TYP MH 10' AFG FIXTURE TYPE BB, 96" TALL




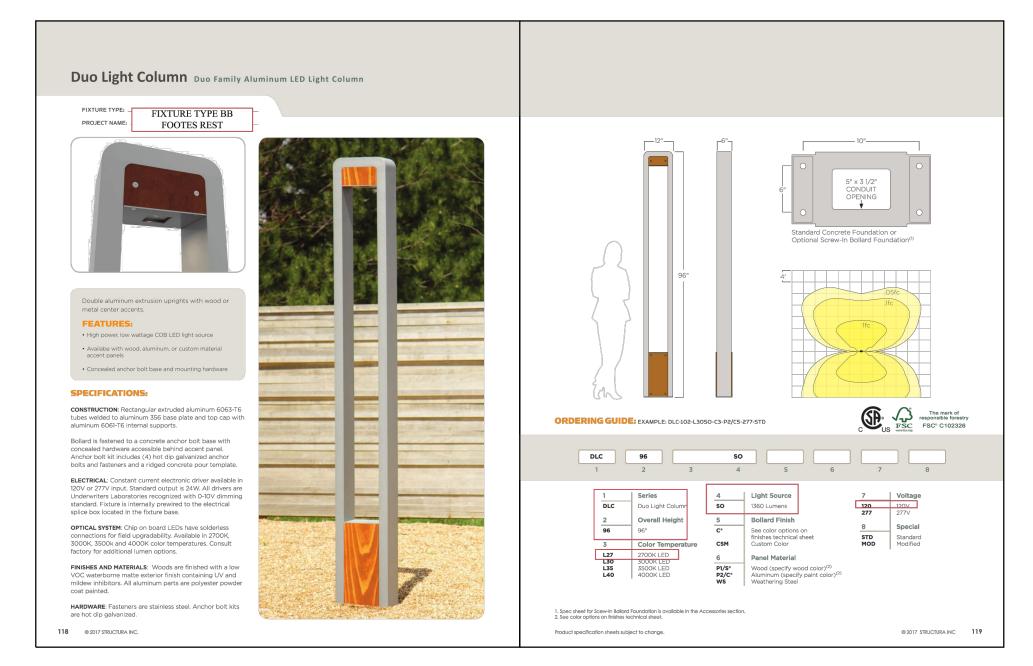


FIXTURE TYPE BB1, 24" TALL



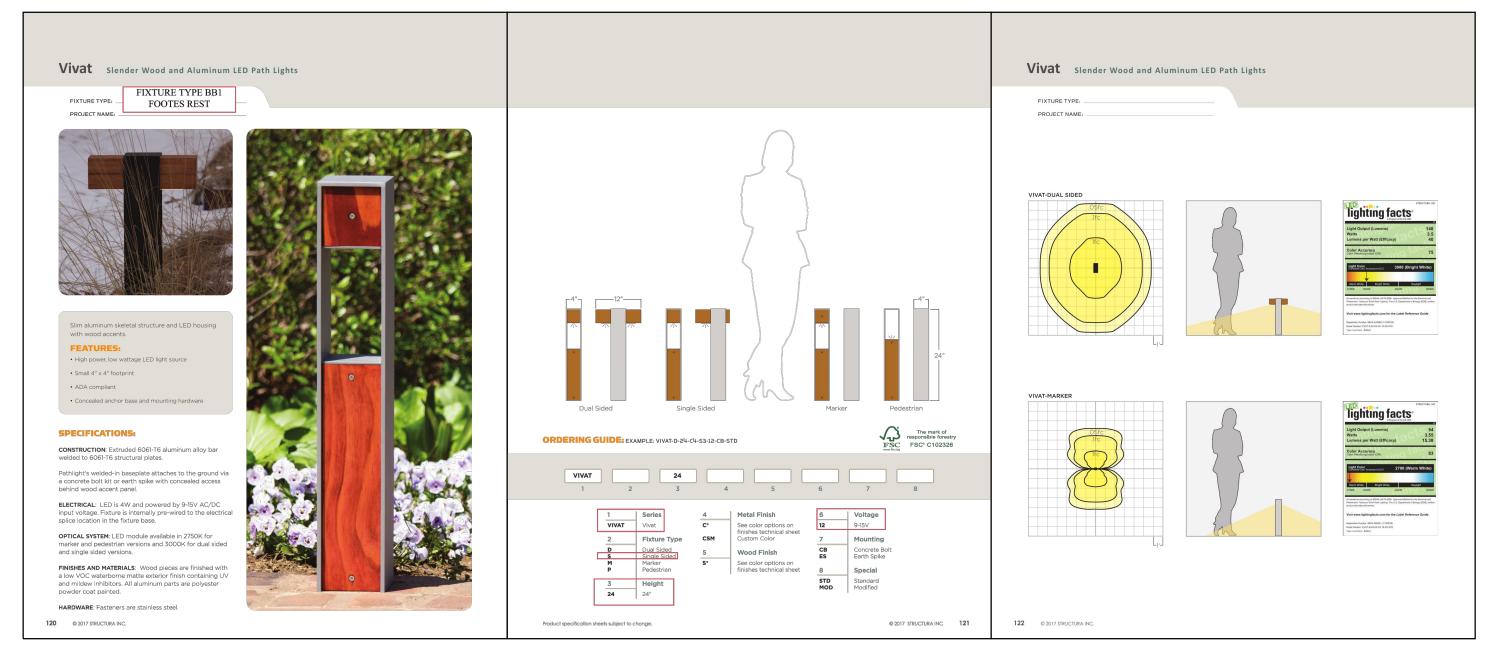

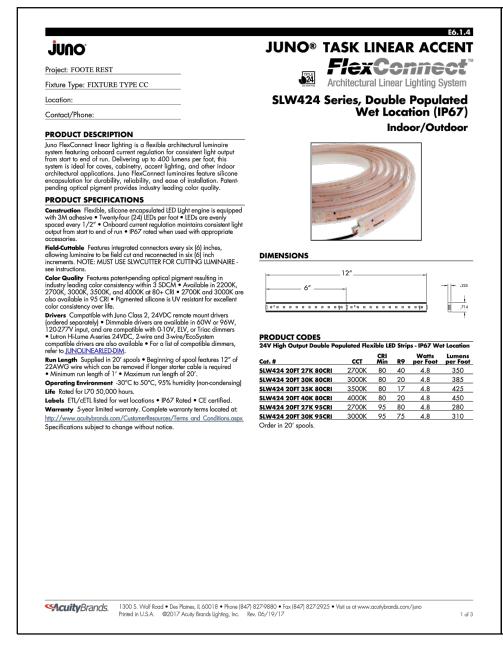

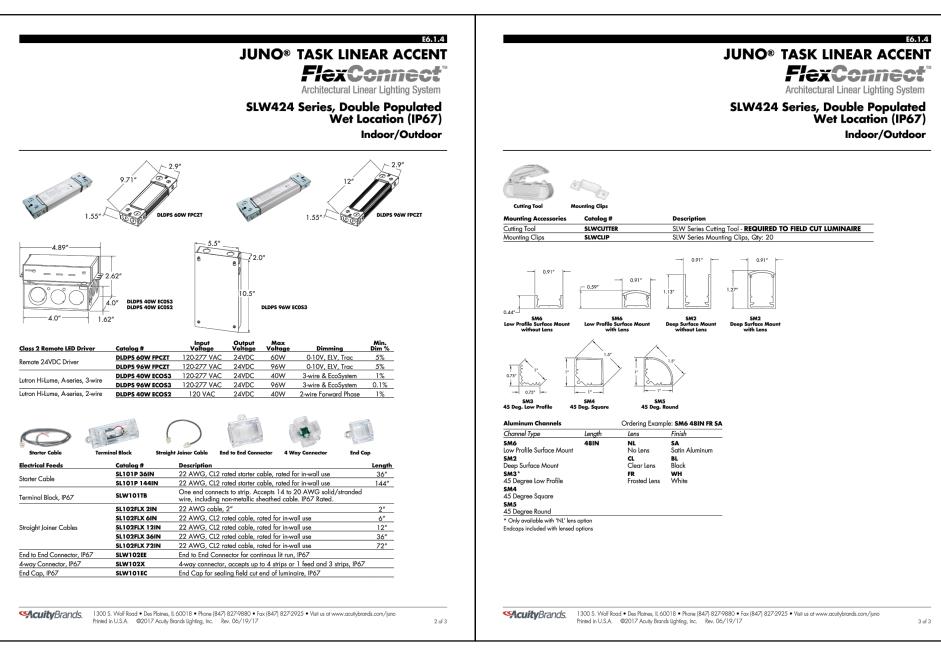

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BLOCK 11

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AEC PROJECT #: 17075

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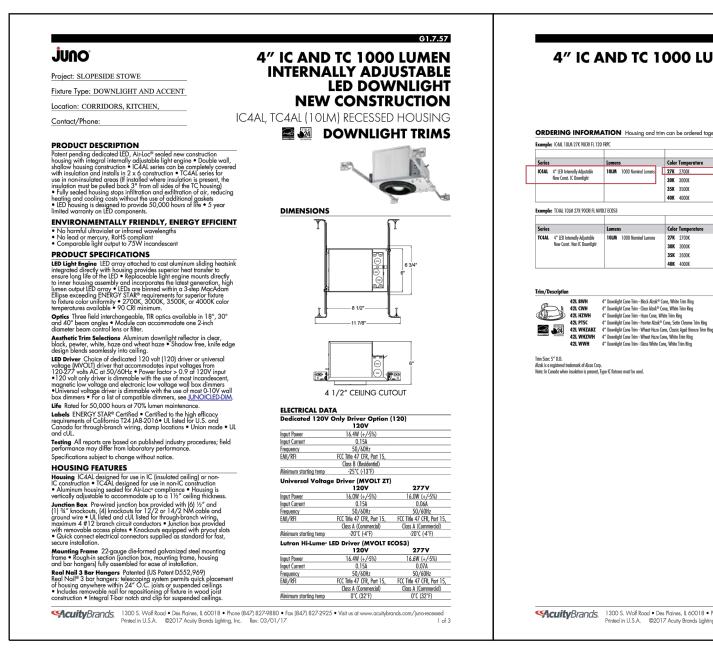
09-06-17 PLANNING SUBMITTAL


Drawn By: Checked By:

SOH AEC

LIGHT
FIXTURE
SPEC
SHEETS
NTS

FIXTURE TYPE DD, RECESSED 10-12' AFG



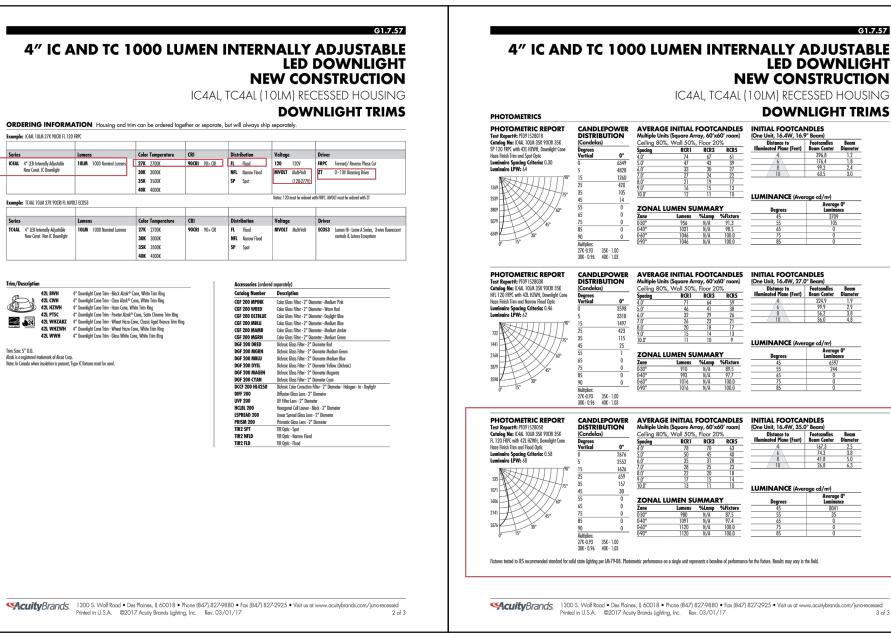

FIXTURE TYPE EE, 12' AFG



EXTERIOR LIGHTING

PHOTOCELL AND TIMECLOCK TO TURN LIGHTS ON AT DUSK AND TURN LIGHTS OFF AT SUNRISE. AT GUEST DECKS LIGHTING WILL BE CONTROLLED WITH ON/OFF

FIXTURE TYPE SS, 4' AFG



FIXTURE TYPE SS1, 4' AFG FIXTURE TYPE SS2





PLANNING SUBMITTAL - NOT FOR CONSTRUCTION

AEC PROJECT #: 17075 DATE: | ISSUE: |09-06-17| PLANNING SUBMITTAL

LIGHT **FIXTURE SPEC SHEETS**

NTS